PROJECT SUMMARY						
BUILDING AREA	221 GSF					
OCCUPANCY TYPE	MIXED — CONSIDERED S—2 STORAGE, LOW HAZARD					
CONSTRUCTION TYPE	TYPE V B (UNPROTECTED)					
AUTOMATIC FIRE SPRINKLER SYSTEM	FULLY SPRINKLERED					

# APPLICABLE CODES

TO THE BEST OF MY KNOWLEDGE, THESE DRAWINGS ARE COMPLETE, AND COMPLY WITH FBC 2014

THE DESIGN AND CONSTRUCTION OF THIS PROJECT SHALL COMPLY WITH THE FOLLOWING CODES AND STANDARDS. SHOULD THERE BE A CONFLICT BETWEEN ANY CODE REQUIREMENTS, COMPLY WITH THE REQUIREMENT THAT PROVIDES THE GREATEST DEGREE OF LIFE SAFETY.

A. FBC (FLORIDA BUILDING CODE), 2014

1. FBC——MECHANICAL 2. NEC (NATIONAL ELECTRICAL CODE) 2008; FBC CHAPTER 27

3. FBC-ACCESSIBILITY 4. FBC REFERENCES-CHAPTER 35

B. FLORIDA FIRE PREVENTION CODE 5th EDITION, INCLUDING

1. NFPA 1-2012 2. NFPA 101-2012

C. UL FIRE RESISTANCE DIRECTORY 2015 D. FEDERAL REQUIREMENTS INCLUDING:

1. OSHA (OCCUPATIONAL SAFETY & HEALTH ADMINISTRATION, US DEPARTMENT OF LABOR, CFR 29 AS

E. CONSTRUCTION, ALTERATION AND DEMOLITION SHALL COMPLY WITH NFPA 241.

		I	
SHEET NUMBER	SHEET TITLE	DRAWING REVISION NUMBER	DRAWING REVISION DATI
ARCHITECTURAL	•		
	COVER & INDEX		
A-01	DEMOLITION FLOOR PLAN & PROPOSED FLOOR PLAN	1	09/27/2016
A-02	INTERIOR ELEVATONS	1	09/27/2016
A-03	FINISH & DOOR SCHEDULE, DETAILS	1	09/27/2016/1
∫ A−04	CATWALK AND LADDER DETAILS	1	09/27/2016 }
\ A-05	CEILING LID FRAMING PLAN AND SECTIONS	1	09/27/2016 }
	<del></del>		
STRUCTURAL			
S-001	GENERAL NOTES		
S-002	FLOOR SLAB PLAN		
S-003	PLATFORM PLAN AND DETAILS		
MECHANICAL			
M-1	MECHANICAL PLAN	1	09/27/2016
PLUMBING			
P-1	PLUMBING PLAN		
P-2	PLUMBING SCHEDULE		
ELECTRICAL	Lucted Detuils a Dioph Duophus	,	
E-1	NOTES, DETAILS & RISER DIAGRAMS		
E-2	ELECTRICAL FLOOR PLAN & PANEL SCHEDULE		

# ARCHITECT OF RECORD

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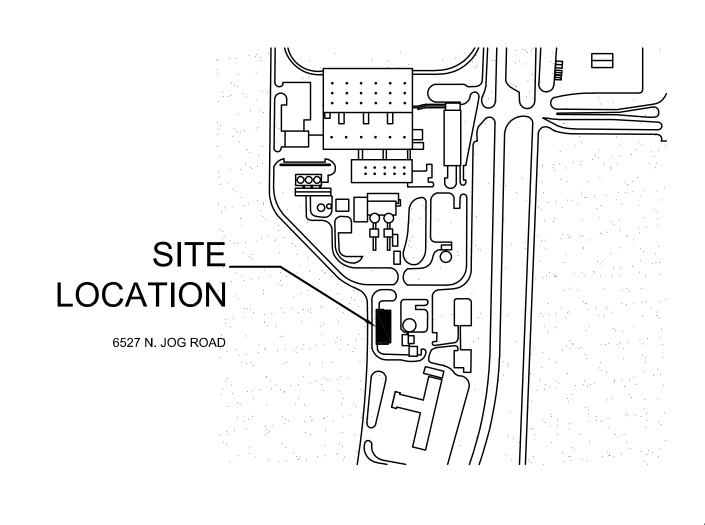
TEL: (561) 881-8999


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SWA-PBC MAINTENANCE FACILITY LOCKER ROOM EXPANSION





6527 N. JOG ROAD WEST PALM BEACH, FL

S + A Project No. 16003

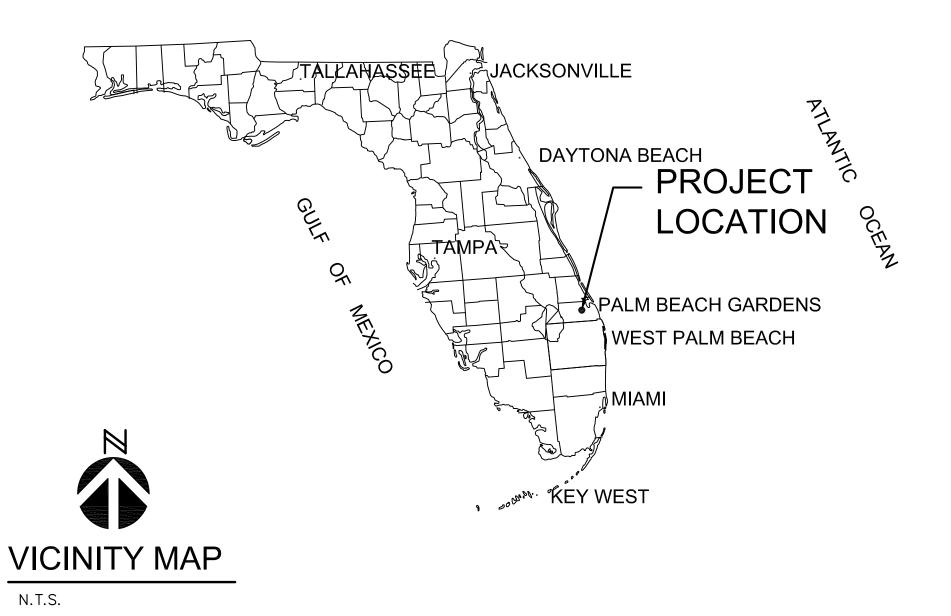



Architecture • Planning • Interior Design


TO THE BEST OF MY KNOWLEDGE, THESE DRAWINGS AND THE PROJECT MANUAL ARE COMPLETE AND COMPLY WITH "THE FLORIDA BUILDING CODE 2014", THE "FLORIDA FIRE PREVENTION CODE; FIFTH ADDITION", AND OTHER APPLICABLE CODES AND REGULATIONS. AS DETERMINED BY THE LOCAL AUTHORITY IN ACCORDANCE WITH FBC CH. 105 AND 633 FLORIDA STATUTES.

BID SET CONSTRUCTION DOCUMENTS

7/14/2016

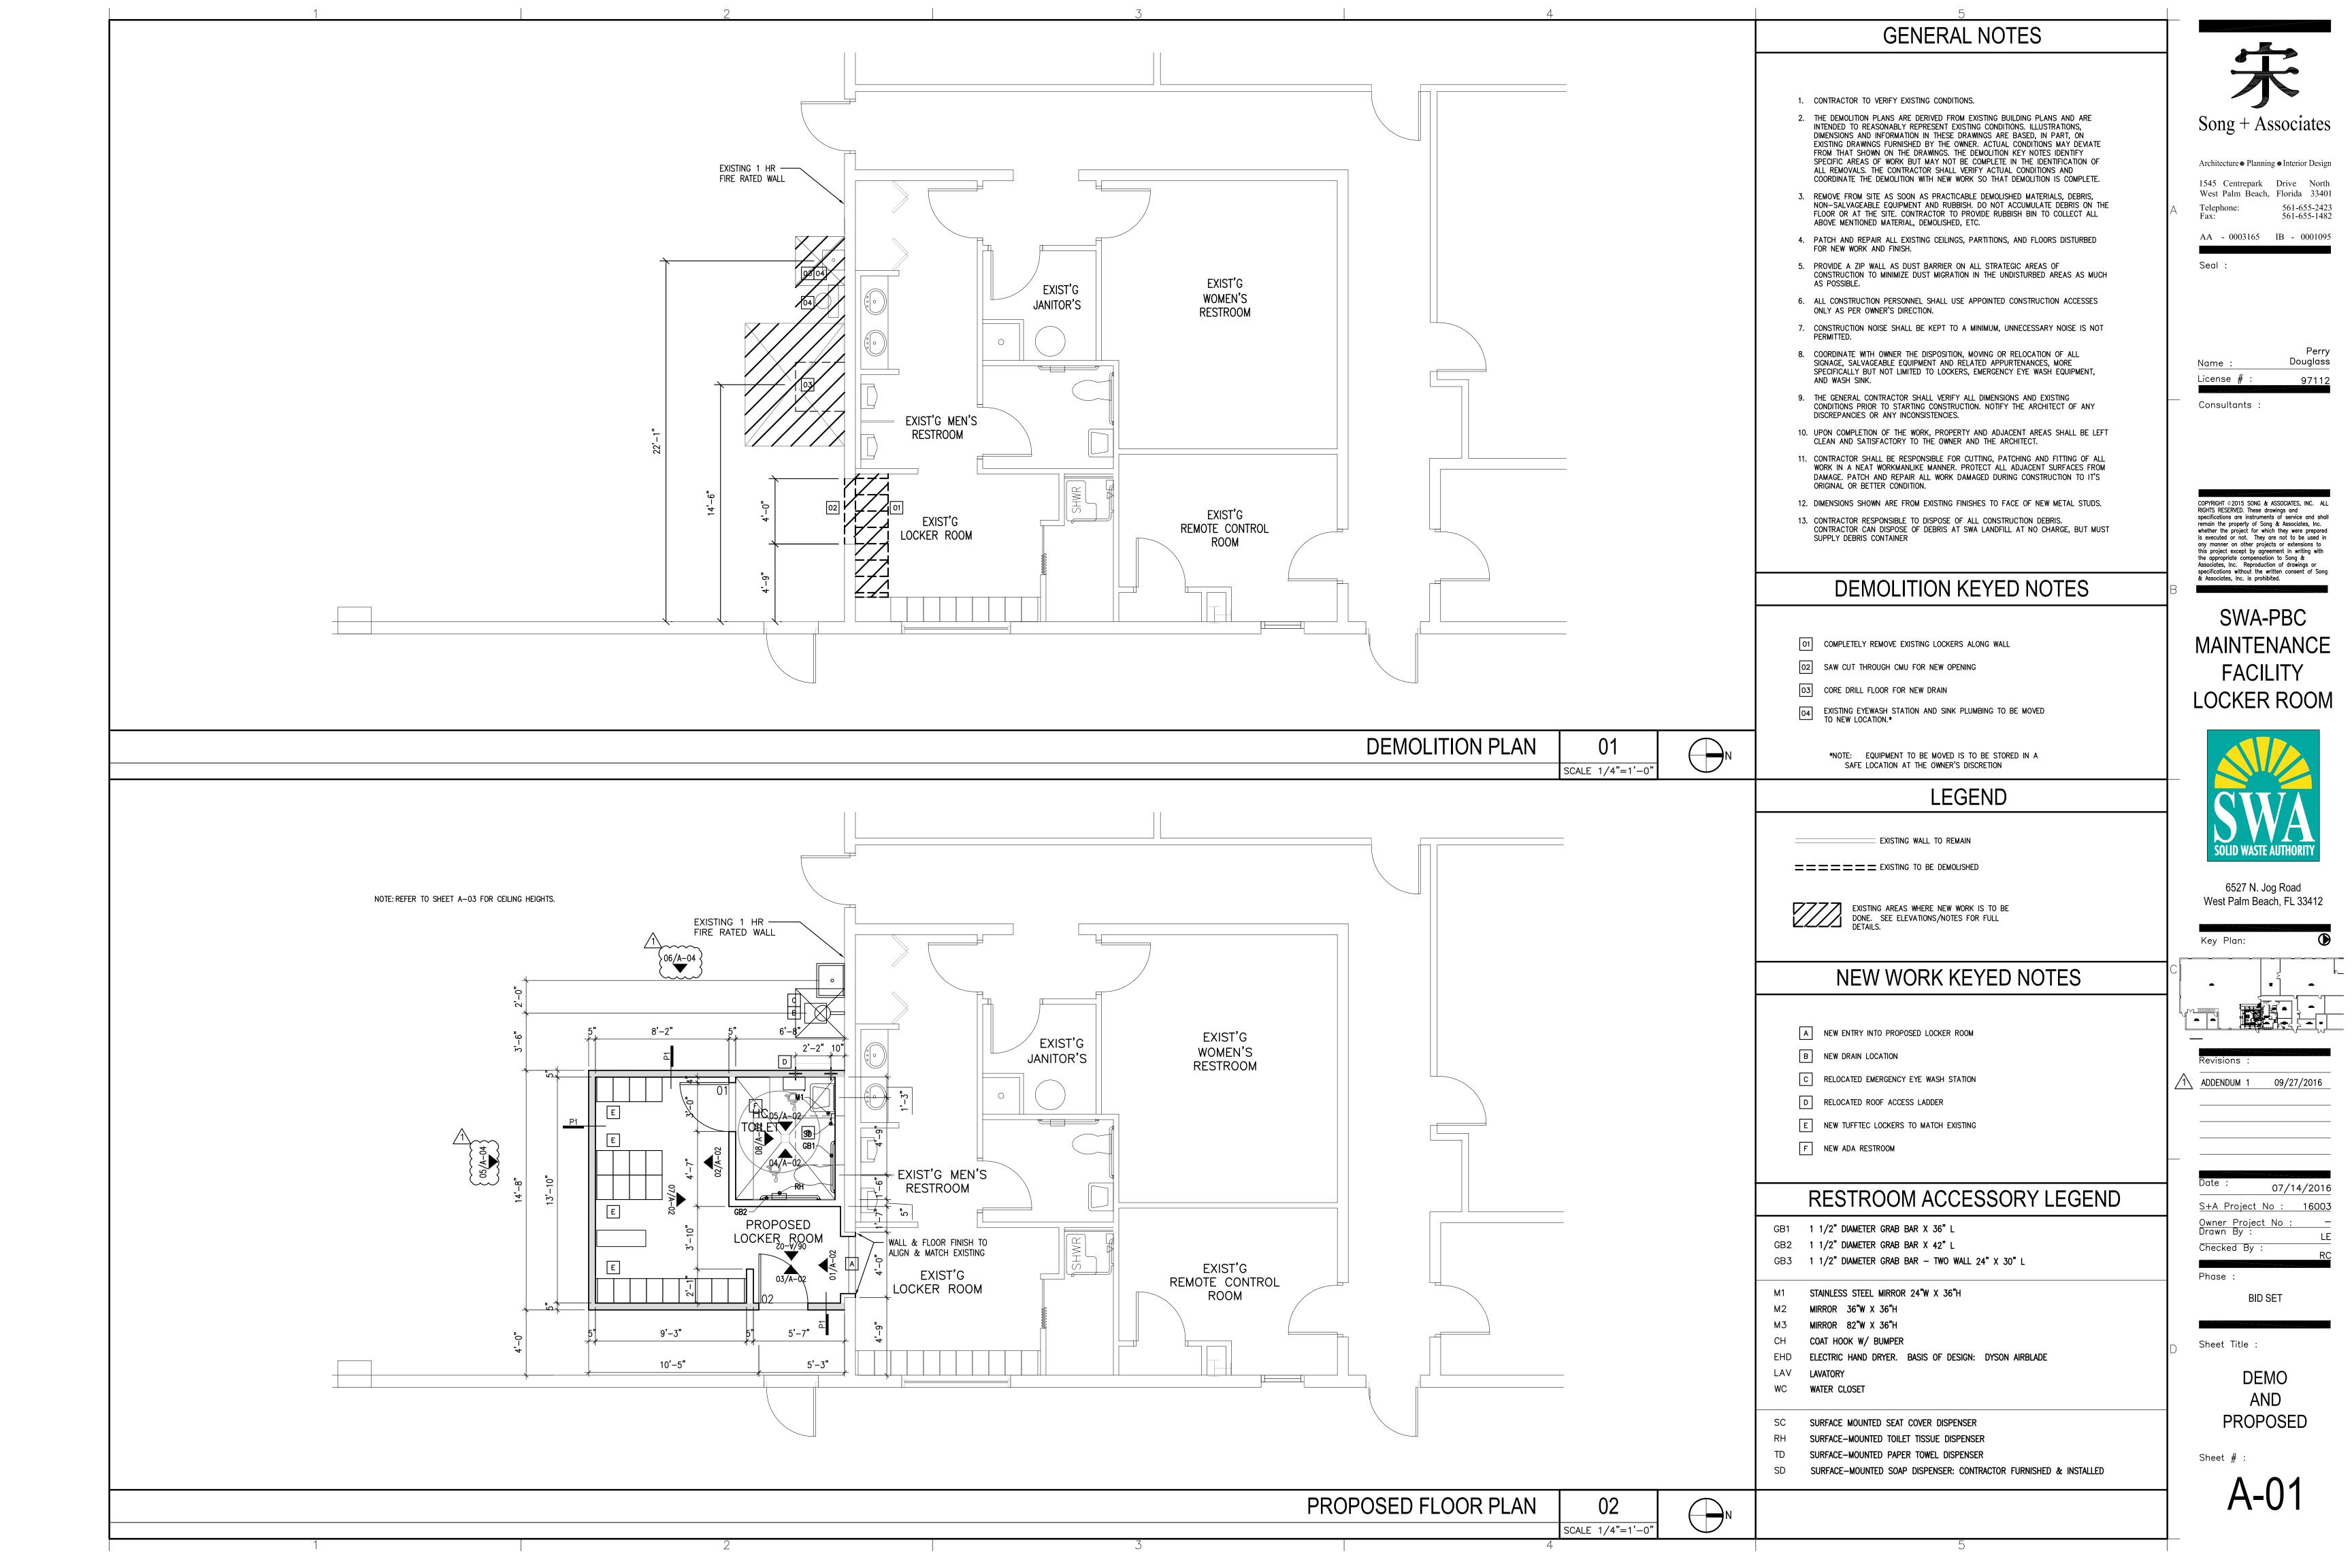

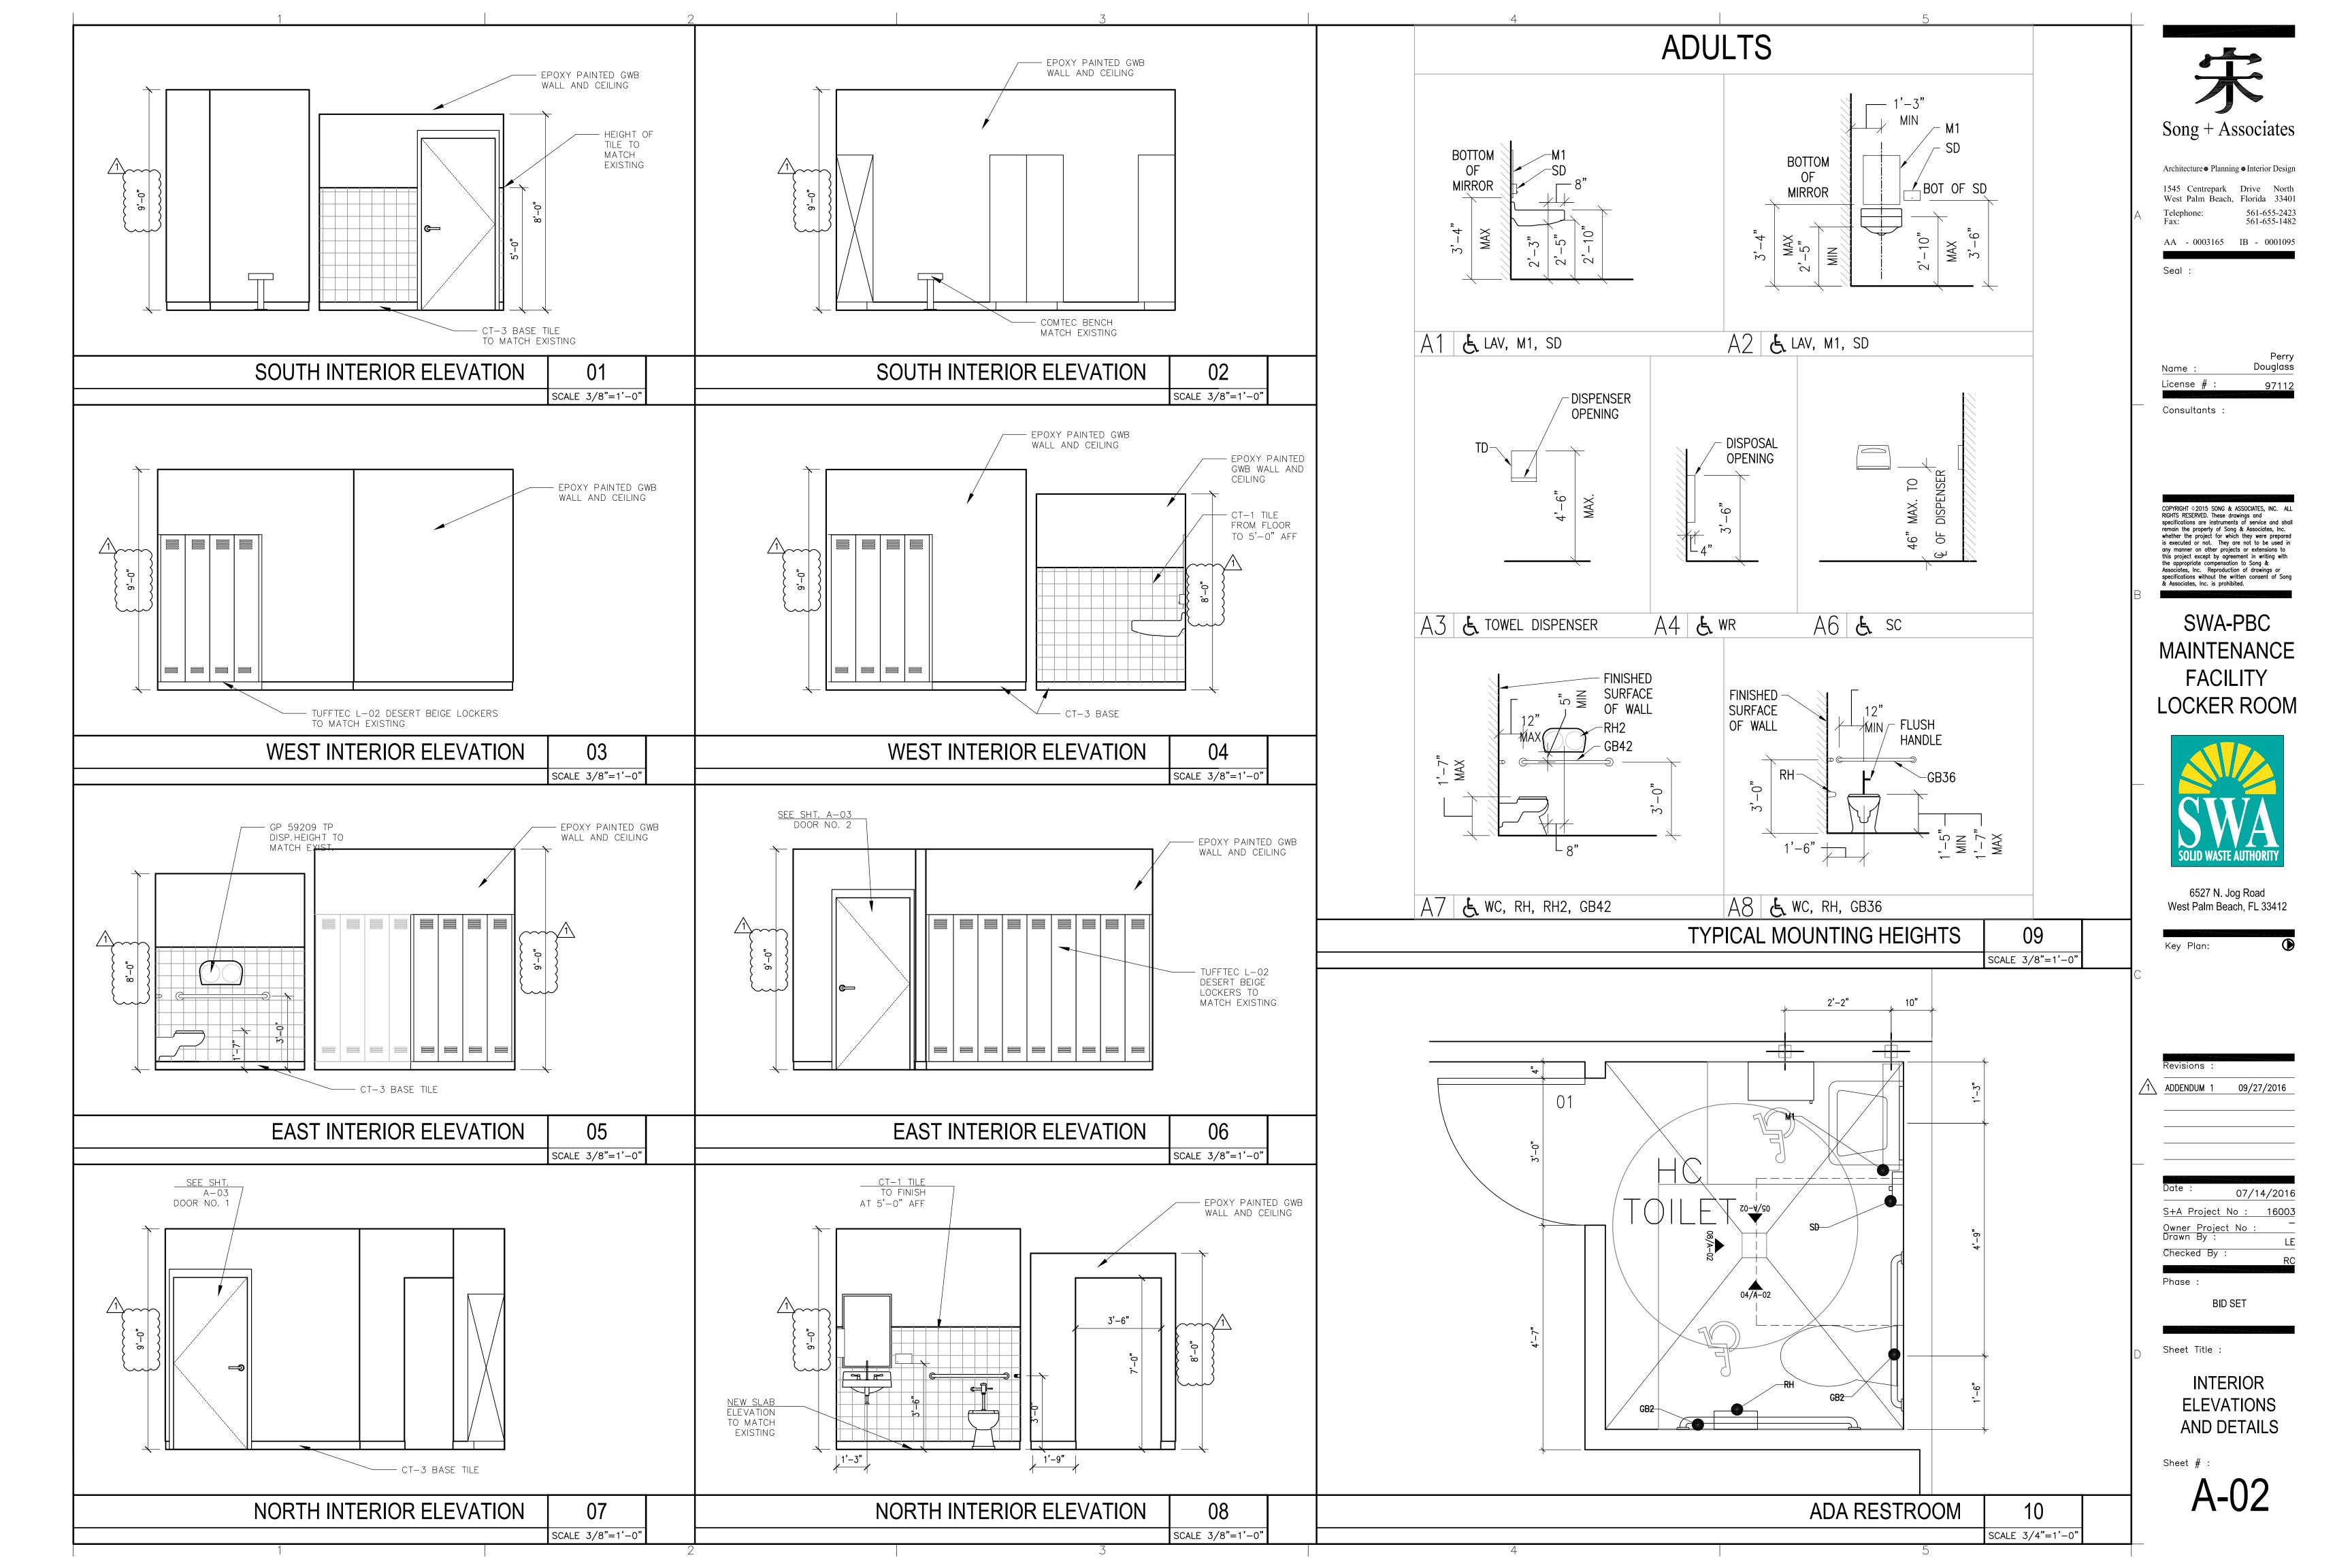

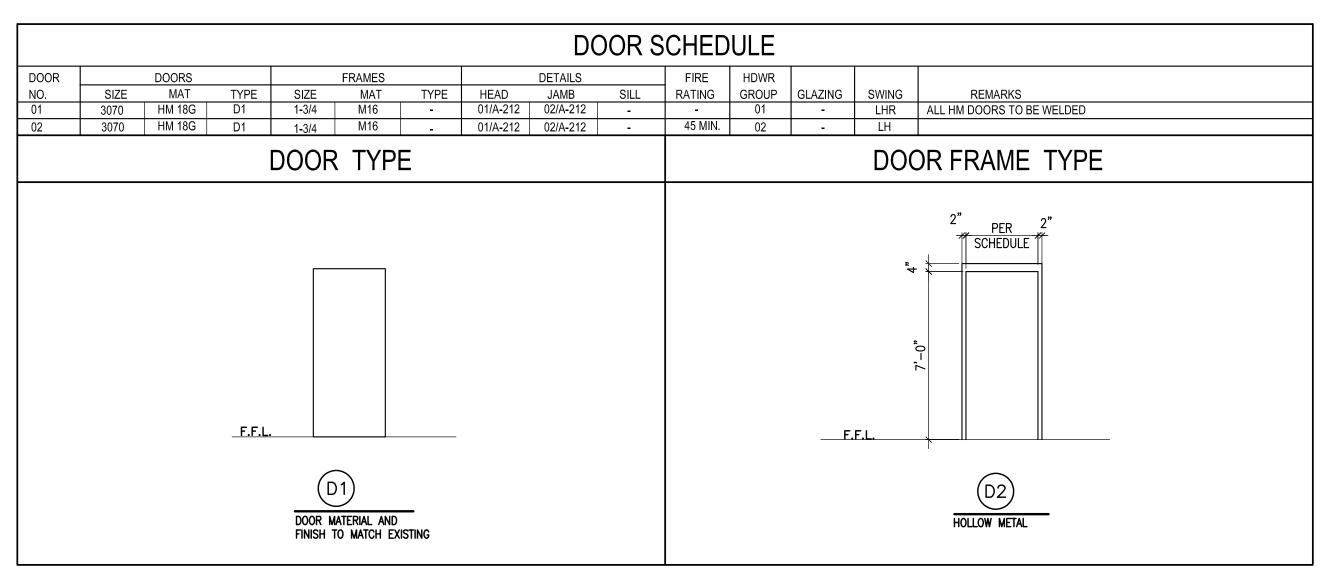

NOTES: DOORS SHALL COMPLY WITH NFPA 101-2012 EDITION CHAPTER 7, SECTION 7.2.1


							FINISH SC	CHED	ULE				
ROOM ROOM		FLOOR	BASE	NO	PRTH	<u> </u>	WALLS EAST	W	EST	SOUTH		CEILING	
NO.	NAME	FIN.	FIN.	MAT.	FIN.	MAT.	FIN.	MAT.	FIN.	MAT.	FIN.	MAT.	REMARKS
01	MEN'S LOCKER ROOM	CT-2	CT-3	GWB	PNT & 14/A-04	GWB	PNT & 14/A-04	GWB	PNT & 14/A-04	GWB	PNT & 14/A-04	GWB	SEE DTL. 5
	ADA RESTROOM	CT-2	CT-3	CT-1	PNT & 14/A-04	CT-1	PNT & 14/A-04	CT-1	PNT & 14/A-04	CT-1	PNT & 14/A-04	GWB	
	1				F	INISH	LEGEND AN	D SPE	CIFICATIONS	6			
	LEGEND	SPEC	CIFICATION	S									
	TILE	CT-1: MANUFACTURER: DALTILE COLLECTION: SEMI-GLOSS COLOR: ALMOND 0135 SIZE: 6"x6" STACKED PATTERN											
	FLOOR	CT-2: MANUFACTURER: DALTILE COLLECTION: GRANITI SERIES COLOR: DUNA DI SABBIA CD98 SIZE: 8"x8" STACKED PATTERN											
	GROUT			: #85 — A ETE #17 —	LMOND - MARBLE BEIGE								
	BASE	CT-3:	COLLECT										
	INTERIOR PAINT			TO	MATCH EXISTING PAIN - SHERWIN WILLIAMS	COLOR IN LOW L	HELL FINISH, CONTRAC USTER LATEX ENAMEL, STING PAINT COLOR (A						

### MATERIAL ABBREVIATION:

GWB: GYPSUM WALL BOARD, MOISTURE RESISTANT, ON ALL WALLS AND CEILINGS, UNLESS NOTED OTHERWISE. FCB: FIBER CEMENT BOARD, ON ALL SHOWER & WET WALLS

### FLOORING NOTES

- 1. TILE LAYOUT IS DIAGRAMMATIC IN NATURE
- 2. TILE SHOULD RUN CONTINUOUS FROM EXISTING LOCKER ROOM, TO NEW
- 3. CONTRACTOR TO REPLACE TILE DAMAGED DURING DEMO IN EXISTING MEN'S LOCKER ROOM, MATCH GROUT LINES TO EXISTING

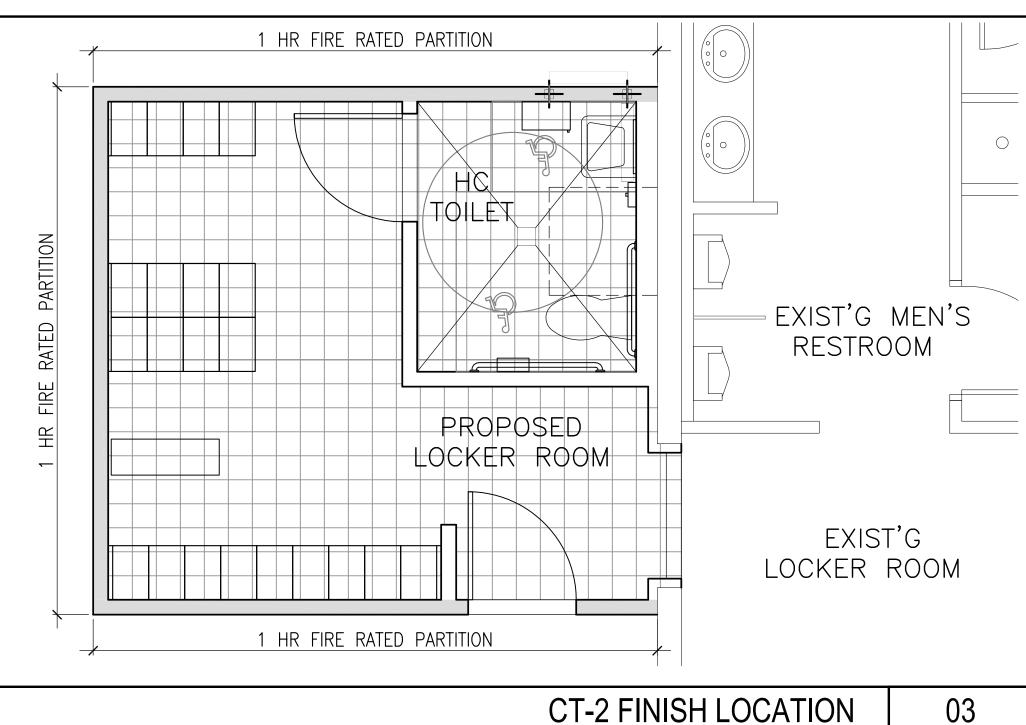

## HARDWARE NOTES

PROVIDE EACH DOOR UP TO 7'-0" WITH (3) HINGES EACH

COLUMNOS NIDAGO ANICI EZO

HARDWARE GROUP 1

SCHLAGE ND40S ANSI F76
BATH/BEDROOM PRIVACY LOCK

PUSH-BUTTON LOCKING. CAN BE OPENED FROM OUTSIDE WITH SMALL SCREWDRIVER, TURNING INSIDE LEVER, OR CLOSING DOOR RELEASES BUTTON. INSIDE LEVER IS ALWAYS FREE FOR IMMEDIATE EGRESS.

DOOR LEVEL TO BE RHO, FINISH TO MATCH EXISTING

HARDWARE GROUP 2

SCHLAGE ND53PD ANSI F109

(08) (A-03)

3" 2.5 PCF

3/8" = 1'-0"


ENTRANCE LOCK

TURN/PUSH-BUTTON LOCKING; PUSHING AND TURNING BUTTON LOCKS OUTSIDE LEVER, REQUIRING USE OF KEY UNTIL

UTTON IS MANUALLY UNLOCKED. PUSH-BUTTON LOCKING; PUSHING BUTTON LOCKS OUTSIDE LEVER UNTIL UNLOCKED

BY KEY OR BY TURNING INSIDE LEVER. INSIDE LEVER IS ALWAYS FREE FOR IMMEDIATE EGRESS.

DOOR LEVER TO BE RHO, FINISH TO MATCH EXISTING

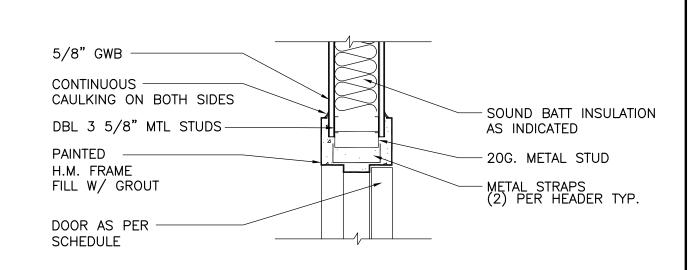

**HEADER DETAIL** 

- ¾" LEVLEROCK FLOOR

7" 18 GAUGE STEEL JOISTS

LOOSE LAID BATT INSULATION

— 2 LAYERS OF ½" SHEETROCK

FIRECODE C CORE GYPSUM


UNDERLAYMENT

%" PLYWOOD

24" O.C.


N.T.S.

1"=1'-0"

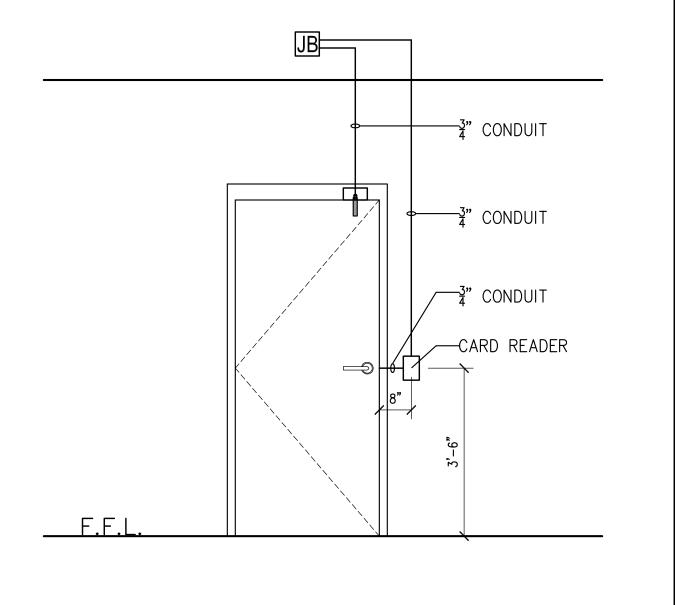

### NOTES:

- 1. PROVIDE 3/4" CONDUIT FROM DOOR DEVICES TO BACKBOX (CARD READER)
- 2. PROVIDE 4  $\frac{11}{16}$ " SQ. BACKBOX, WITH PROPER EXTENSION AND PLATE ON SIDE OF DOOR.
- 3. PROVIDE 2  $\frac{1}{2}$ " DEEP SINGLE GANG MASONRY BOX FLUSH MOUNTED 42" AFF AND 6-12" AWAY FROM DOOR FRAME ON UNSECURED SIDE

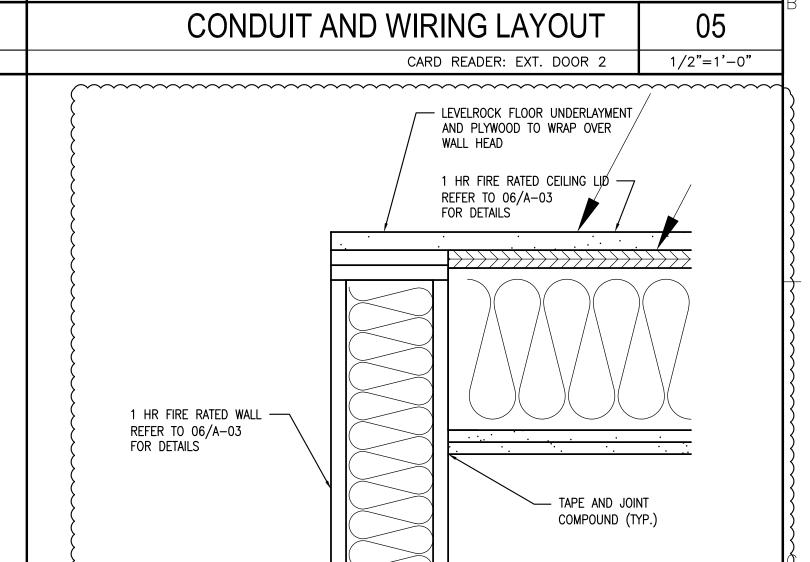

# 

WALL TO CEILING ASSEMBLY DETAIL

## WALL NOTES:

- 1. THESE PARTITION TYPES ARE DIAGRAMMATIC IN NATURE, REFER TO FINISH SCHEDULE
- WALL TAG DESIGNATION IS INTENDED TO INDICATE WALL TYPE ALONG AN ENTIRE WALL PLANE AND/OR SURFACE ALONG THE FULL LENGTH OF A SPACE OR CORRIDOR INCLUDING ASSOCIATED ALCOVES AND NICHES, UNLESS INDICATED OTHERWISE.
- 3. MAXIMUM STUD SPACING & MIN. STUD GAUGE SHALL PROVIDE A MAXIMUM DEFLECTION OF L/240 UNDER A MINIMUM 5 PSF LATERAL LOAD, UNLESS OTHERWISE INDICATED. PROVIDE FRAMING W/ 20 GA. STUDS @ 16" O.C.
- 4. SET FLOOR TRACKS IN TWO CONTINUOUS BEADS OF ACOUSTICAL (NON-HARDENING). IN ADDITION, PROVIDE A CONTINUOUS BEAD OF ACOUSTICAL CAULK BETWEEN THE BOTTOM OF DRYWALL AND CONCRETE
- 5. ALL GWB SHALL CONTAIN MOLD/MILDEW RESISTIVE PROPERTIES, UNLESS OTHERWISE SPECIFIED.
- 6. INTERIOR STUD DOOR HEAD & JAMB FRAMING TO BE DOUBLE 20 GAUGE STUDS, TYP. PROVIDE 20 GAUGE STUDS AT INTERIOR WALLS RECEIVING TILE FINISH.

ong + Associate

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# SWA-PBC MAINTENANCE FACILITY LOCKER ROOM



6527 N. Jog Road West Palm Beach, FL 33412

Povisions :

3"=1'-0"

Key Plan:

ADDENDUM 1 09/27/2016

: 07/14/2016 Project No : 16003

S+A Project No : 16003

Owner Project No : 
Drawn By : 
LE

Checked By : 
RC


Phase :

Sheet Title :


DETAILS AND SCHEDULES


Sheet # :

A-03

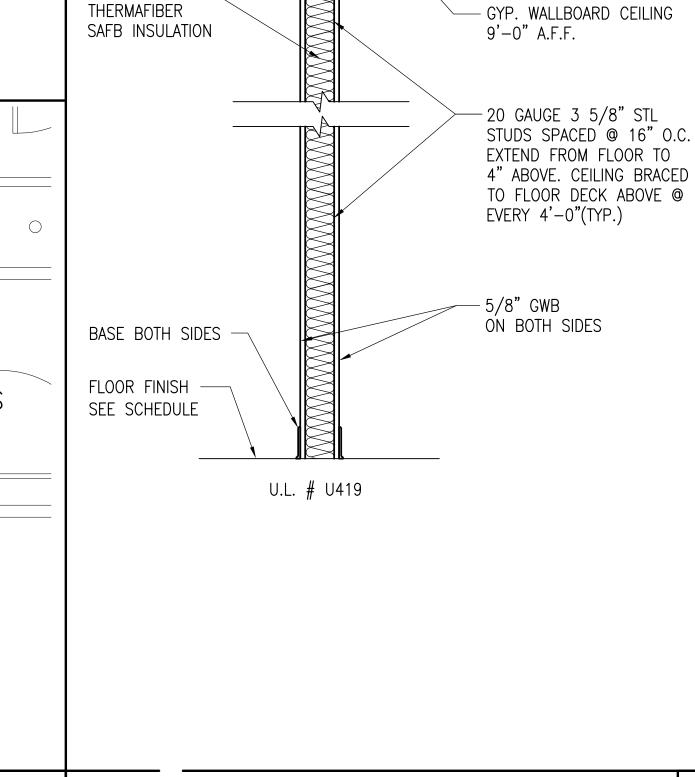

1HR FIRE RATED PARTITION DETAIL

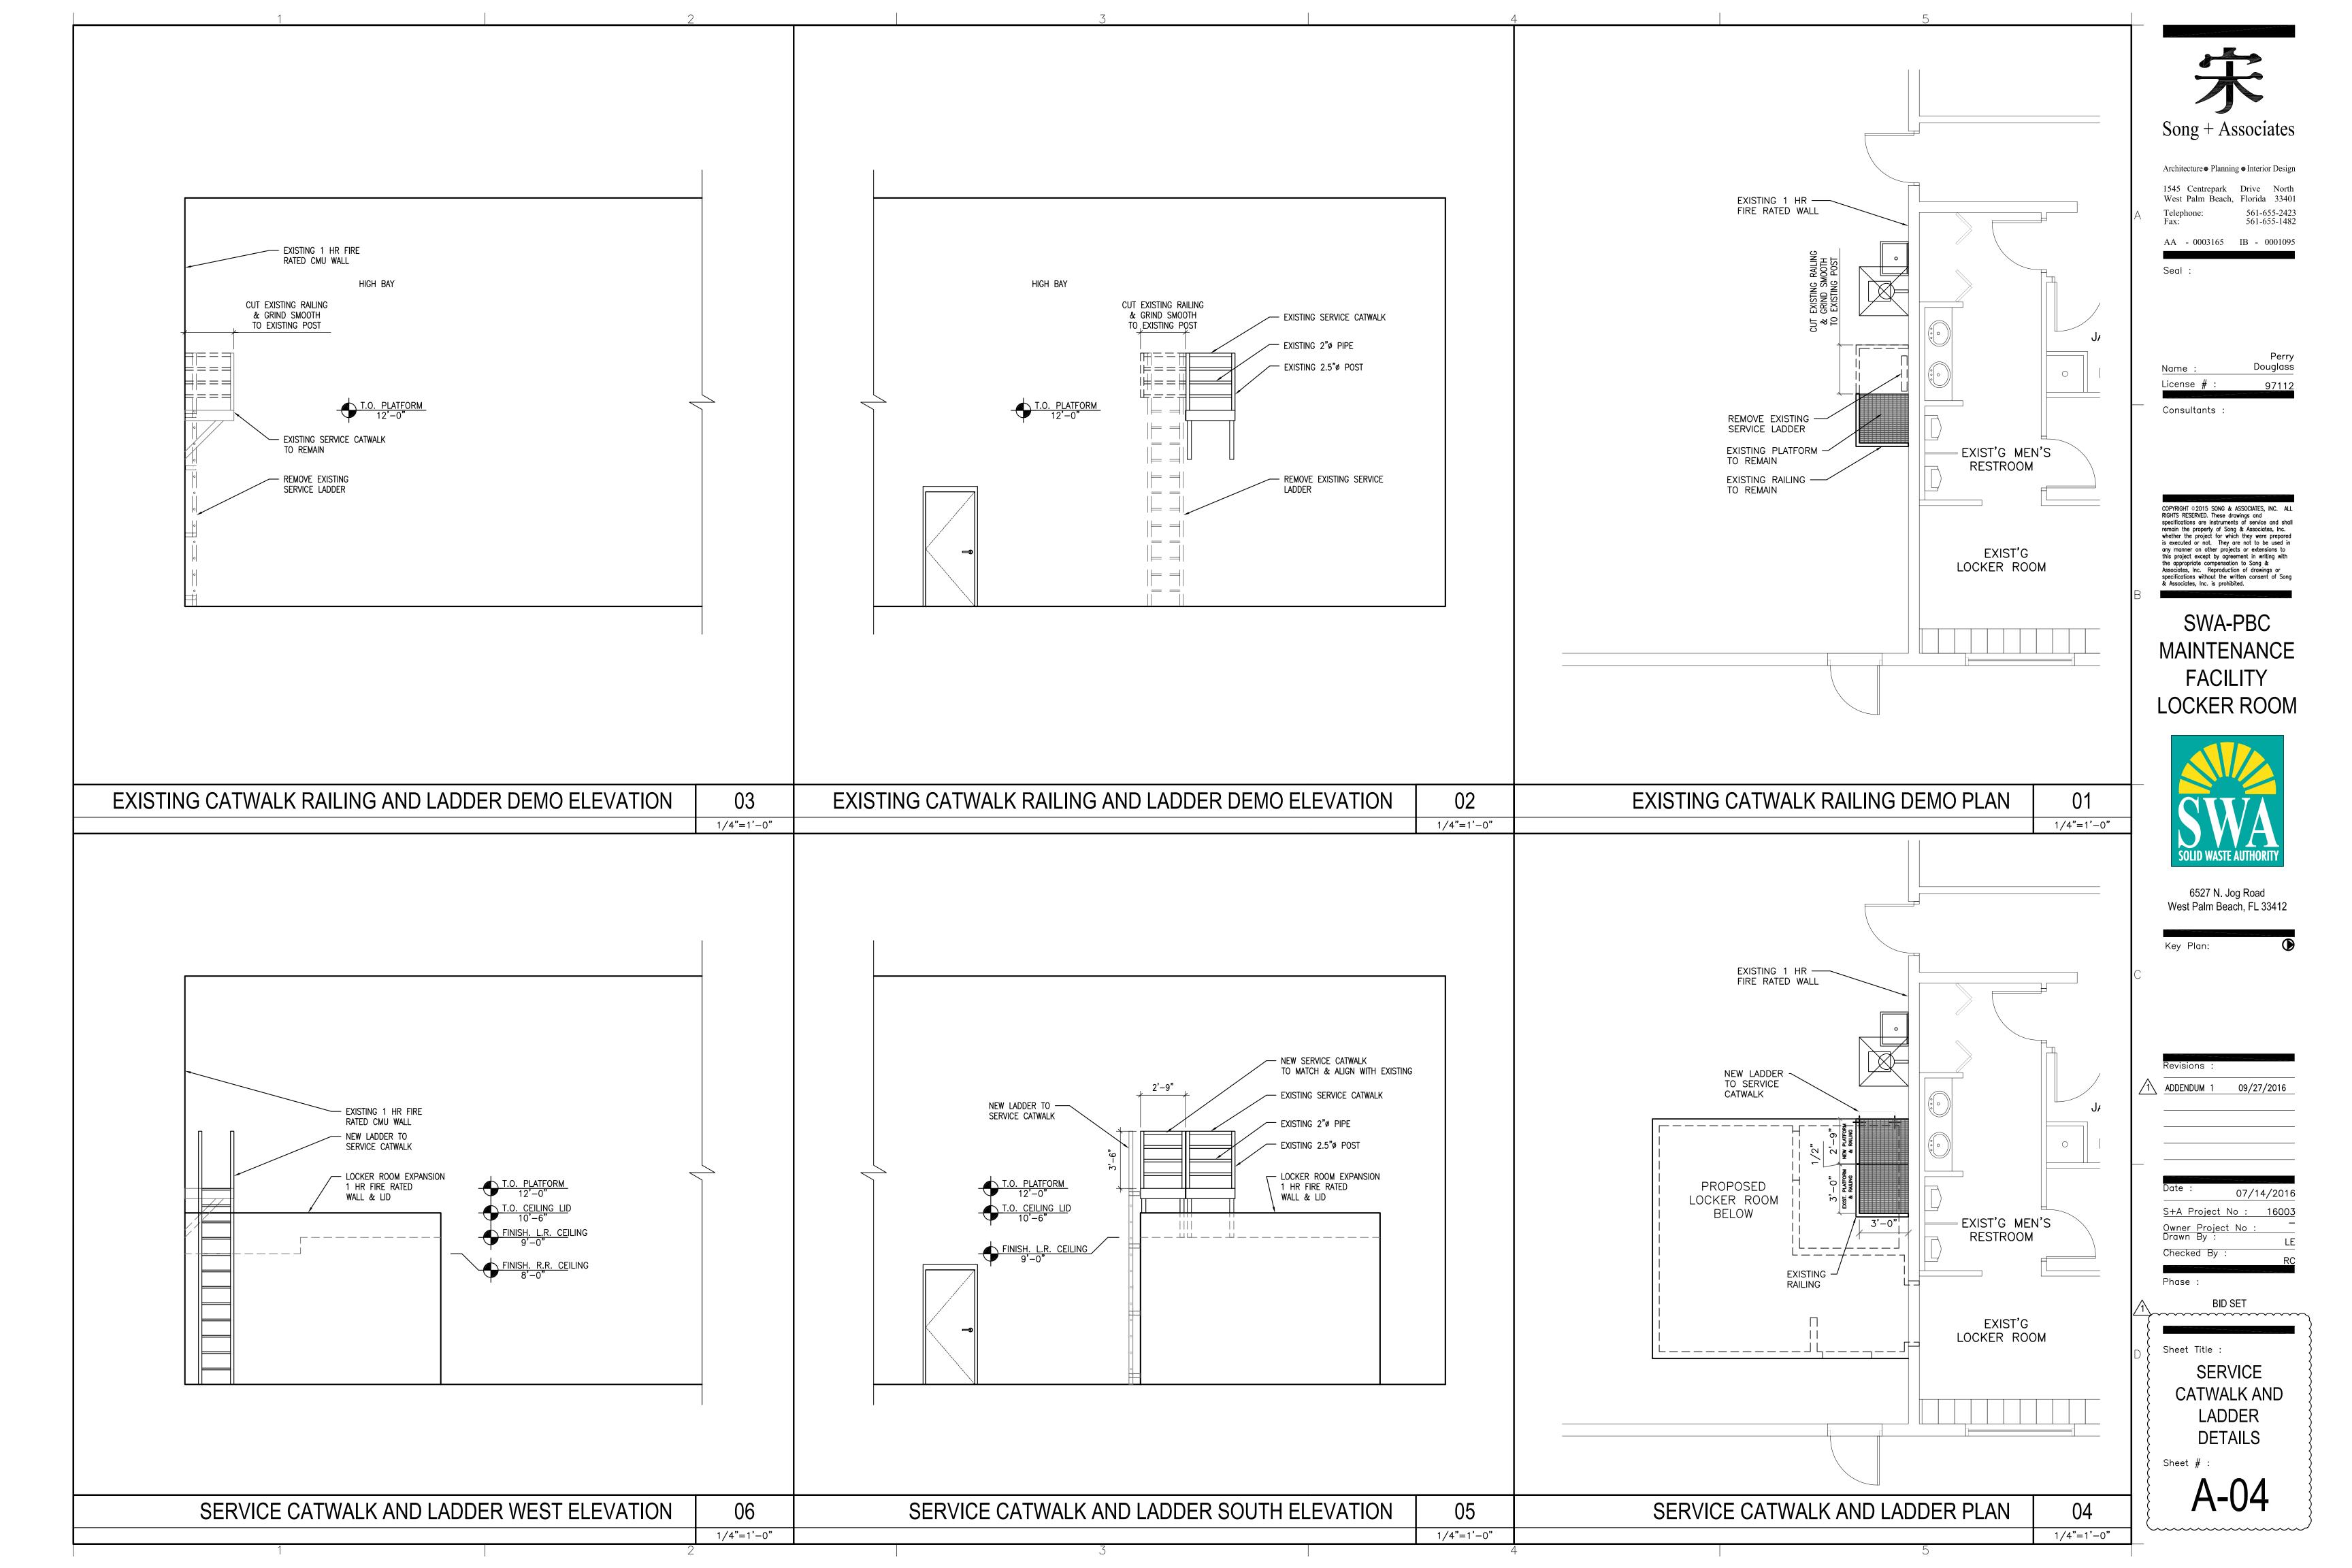

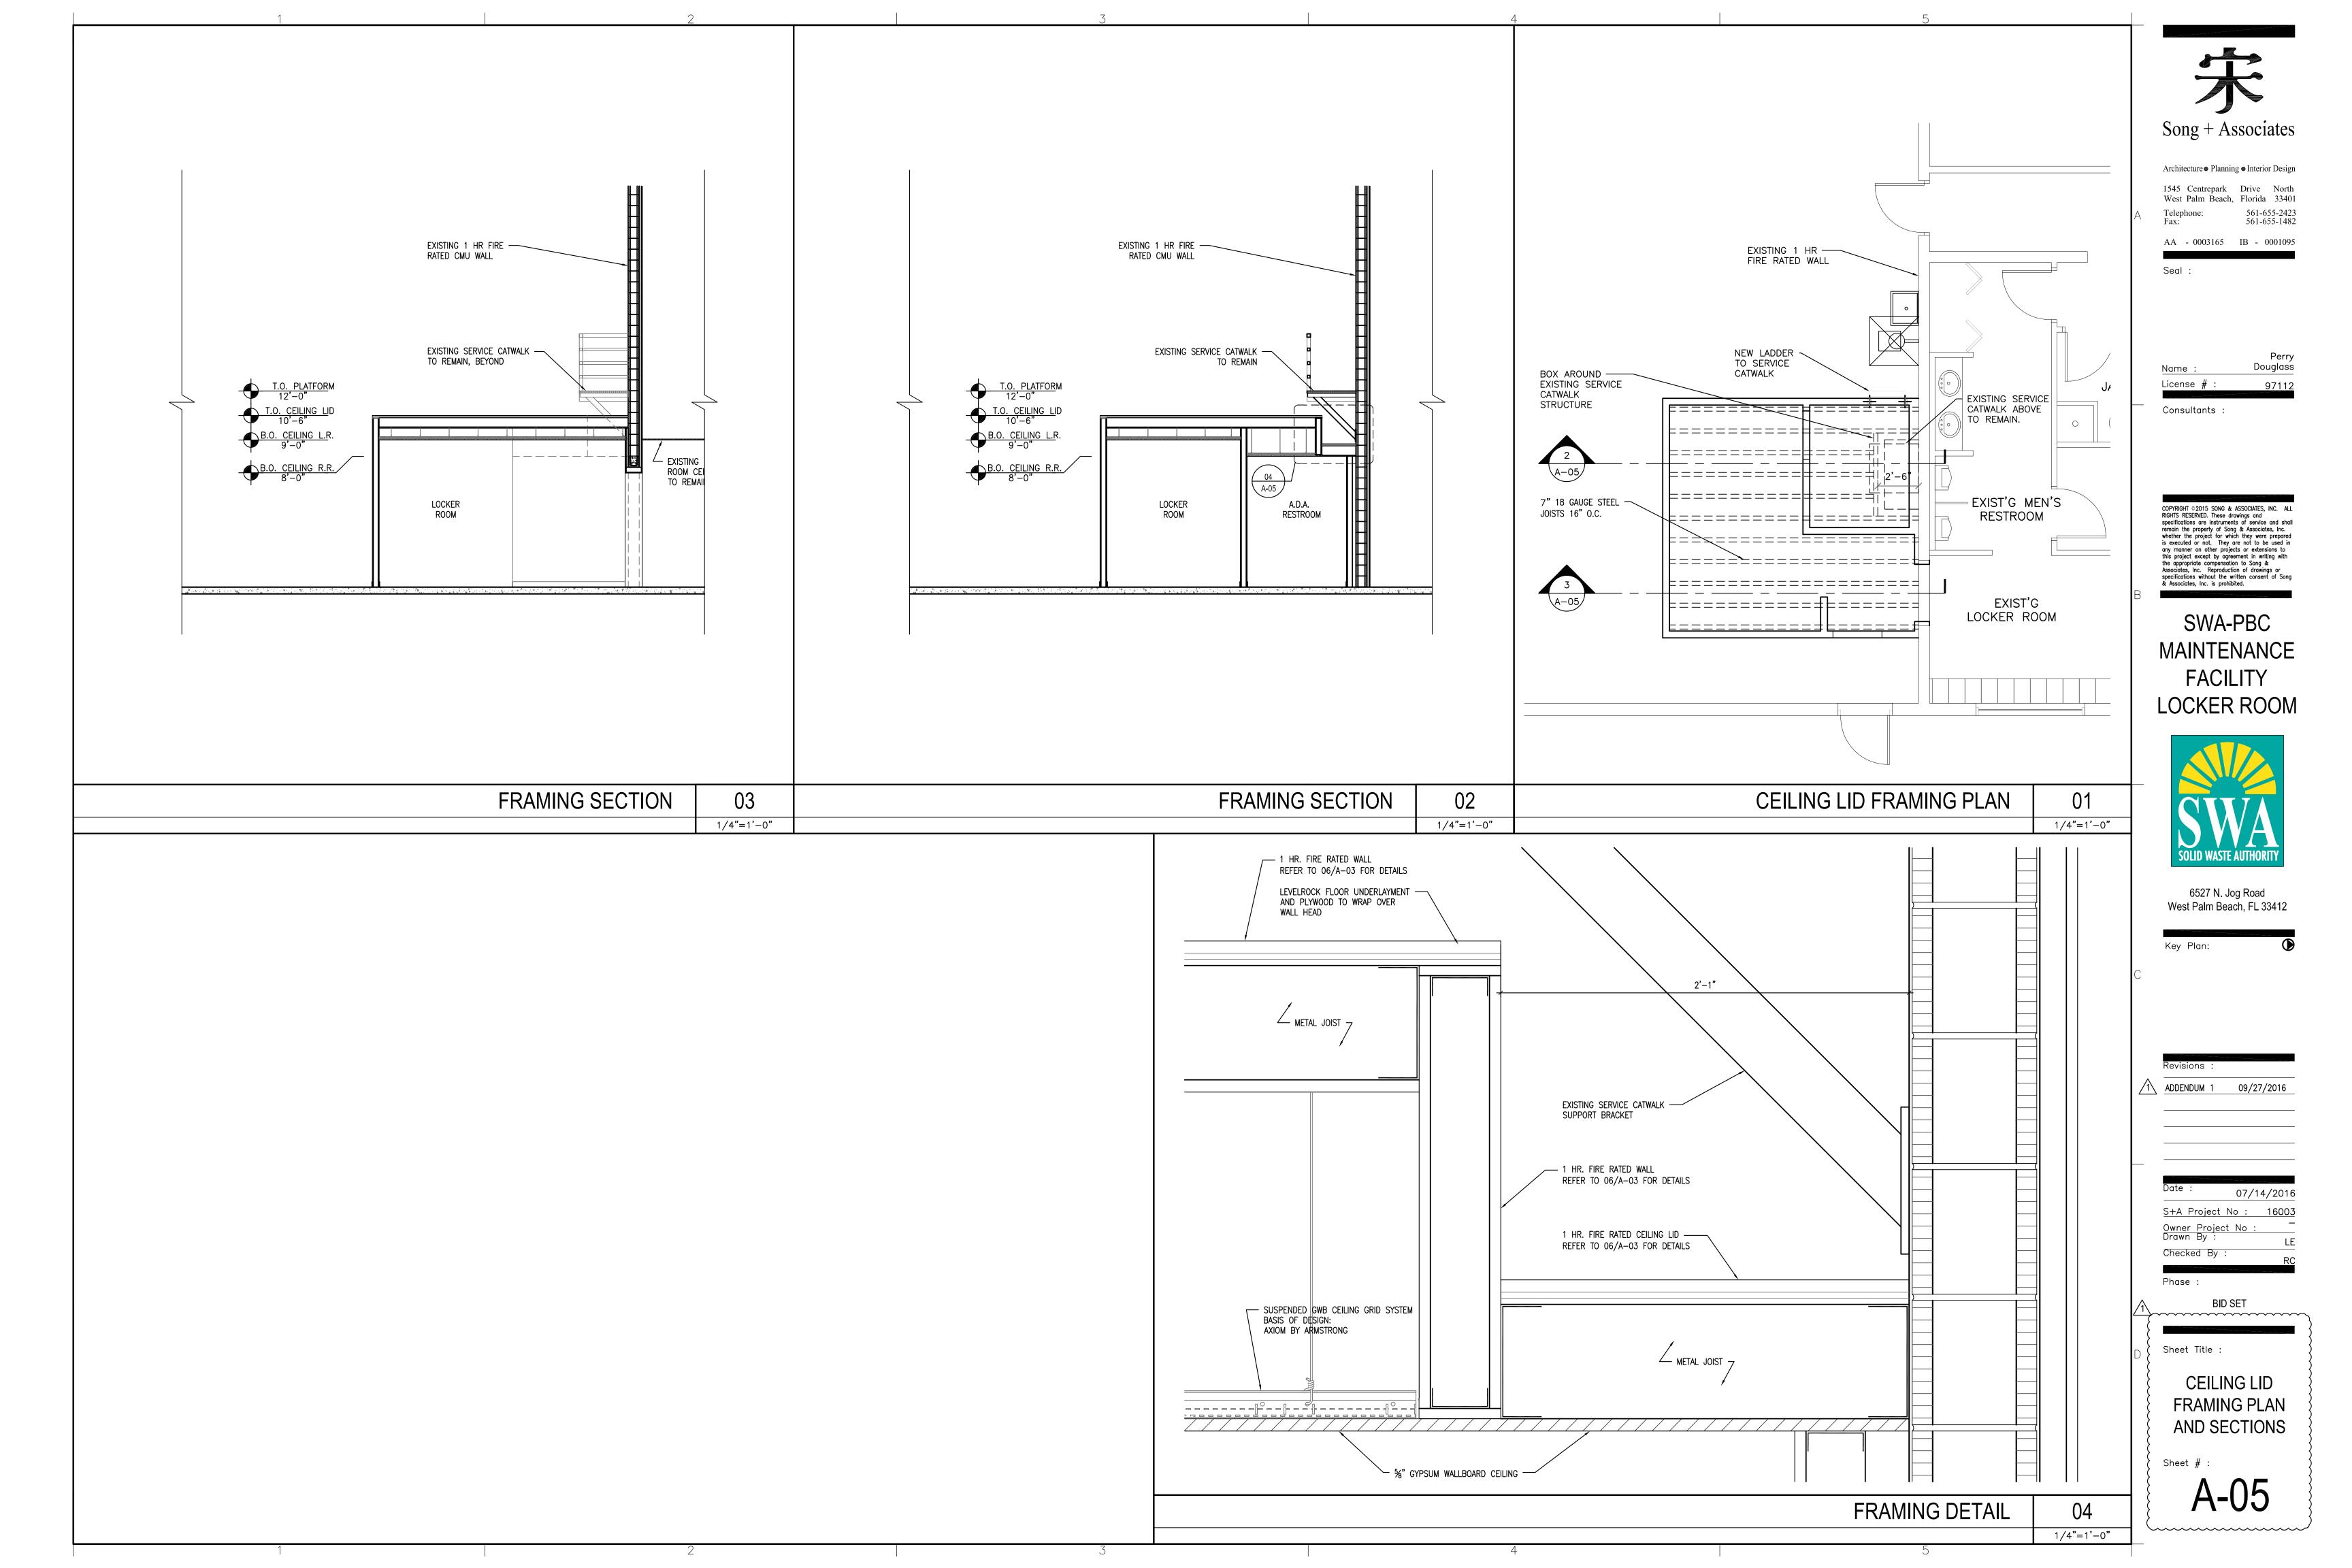

### **GENERAL NOTES:**

- ALL MECHANICAL SYSTEMS ARE TO BE INSTALLED IN ACCORDANCE WITH ALL APPLICABLE SECTIONS OF THE NFPA STANDARDS, ANSI STANDARDS, THE LOCAL BUILDING CODE, NOISE & HEIGHT ORDINANCES, PLANS AND SPECIFICATIONS.
- ALL MATERIALS SHALL BE NEW AND ALL WORKMANSHIP AND MATERIALS SHALL BE IN STRICT ACCORDANCE WITH APPLICABLE LOCAL CODES, PRODUCT APPROVAL, RULES AND DORDINANCES, ANY DAMAGED EQUIPMENT SHALL BE REPLACED OR RESTORED TO ORIGINAL CONDITION.
- THE CONTRACTOR SHALL PROVIDE ALL LABOR, MATERIALS, EQUIPMENT, ACCESS PANELS, CONTROL SYSTEMS, DEVICES, PERMITS AND SERVICES NECESSARY FOR FURNISHING AND INSTALLING A COMPLETE OPERABLE MECHANICAL SYSTEM.
- ALL LOUVERS, GRILLES, PIPING, ETC. SHALL BE PAINTED TO MATCH SURROUNDING COLOR AND TEXTURES AS REQUIRED BY ARCHITECT. VERIFY COLOR AND TEXTURE WITH ARCHITECT. PAINT ALL EXPOSED MECHANICAL EQUIPMENT WITH BENJAMIN MOORE EPOXY ENAMEL 182.
- ALL CUTTING, PATCHING, STRUCTURAL STEEL, WEATHER PROOFING, PAINTING, AND WALL OPENINGS SHALL BE BY THE GENERAL CONTRACTOR.
- ALL OPENINGS IN BUILDING STRUCTURE, FOR DUCTWORK, PIPING, ETC. TO BE 1/2" LARGER (ON ALL SIDES) THEN THE OUTSIDE DIMENSIONS. FILL VOIDS WITH FIRE RETARDANT SILICONE FOAM (I.E. CHASE—FOAM CTC PR—855 BY CHASE TECHNOLOGY CORP.)
- 8. PROVIDE FLEXIBLE DUCT CONNECTORS, RATED AS REQUIRED, TO ALL FANS, A/C UNITS, OR MECHANICAL EQUIPMENT.
- PROVIDE MAINTENANCE AND OPERATION MANUAL ON ALL MECHANICAL EQUIPMENT OR SYSTEMS. PROVIDE 5 SETS OF SUBMITTALS ON ALL HVAC EQUIPMENT. SUBMITTALS SHALL HAVE A SUMMARY SHEET SHOWING ALL SCHEDULED INFORMATION.
- HVAC CONTRACTOR WILL WARRANTY ALL MECHANICAL SYSTEMS, DUCTWORK, THERMOSTATS, AND ALL OTHER EQUIPMENT, PARTS AND LABOR UNDER THESE DRAWINGS AND SPECIFICATIONS FOR A PERIOD OF ONE (1) YEAR AFTER C.O. OF BUILDING. ANY REPAIRS REQUIRING SYSTEM SHUT DOWN WILL BE DONE DURING NON OPERATIONAL PERIODS. HVAC CONTRACTOR SHALL COORDINATE WITH ALL OTHER TRADES PRIOR TO BIDDING AND PURCHASING ANY EQUIPMENT.
- AIR QUALITY SHOULD BE TESTED BEFORE OCCUPANCY AND SHOULD BE INSTRUMENTED AND MONITORED THEREAFTER, OR AT LEAST AT REGULAR INTERVALS

# AIR DISTRIBUTION/DUCTWORK NOTES:

- REFER TO ARCHITECTURAL PLANS FOR CEILING TYPE.
- PROVIDE OFF WHITE FINISH (SUBJECT TO ARCHITECT'S APPROVAL).
- ALL DUCTWORK WHERE ALLOWED BY LOCAL CODES AND AND CEILING RATING SHALL BE 1" LOW PRESSURE DUCT, SEAL CLASS "C" AND AS FOLLOWS:


  A. S/A & R/A-1" THICK FIBERGLASS DUCT BOARD WITH VAPOR BARRIER (R-4.2 MIN.) B. EXHAUST AIR DUCTWORK - GALVANIZED SHEETMETAL B. OUTSIDE AIR DUCTWORK - INSULATED GALVANIZED SHEETMETAL
- ALL DUCTWORK AND DIFFUSERS SHALL BE RATED FOR THE USE, PRESSURE AND TEMPERATURE SPECIFIED AND AS REQUIRED BY THE CEILING SYSTEM RATING.
- ALL DUCTWORK SHALL BE FABRICATED AND INSTALLED IN ACCORDANCE WITH "SMACNA" STANDARDS AND LOCAL BUILDING CODES.
- 6. ALL DUCT SIZES ARE CLEAR INSIDE DIMENSIONS.
- SEAL ALL DUCTS, JOINTS AND SEAMS IN AN APPROVED MANNER AND INSURE
- 8. PROVIDE ACCESS DOORS AS REQUIRED FOR ALL MECHANICAL EQUIPMENT TO SERVICE AND VISUALLY CHECK ROTATION OF FANS AND MOTORS, POSITION OF DAMPERS, REPLACE FIRE DAMPER LINKS, ADJUST OR REPLACE CONTROLS, ETC.
- PROVIDE VANED ELBOWS IN ALL CASES, SPLITTER DAMPERS WHERE INDICATED ON DRAWINGS AND VOLUME CONTROL DAMPERS IN ALL BRANCH DUCTS OR
- 10. TERMINAL AIR DISTRIBUTION DEVICES SHALL BE AS FOLLOWS: CEILING DIFFUSER: EQUIV. TO TITUS MODEL PAS—AA RETURN REGISTER: EQUIV. TO TITUS MODEL 4 FL

### **HVAC NOTES:**


VALVE SHOWN ON PLANS.

DIFFUSER CONNECTIONS.

- HVAC SUBCONTRACTOR SHALL PROVIDE ALL LABOR, MATERIAL, TOOLS AND EQUIPMENT TO INSTALL A COMPLETE AND OPERATING A/C SYSTEM.
- HVAC SUBCONTRACTOR TO PROVIDE ALL REQUIRED HVAC PERMITS. COMPLY WITH NFPA-90A AND ALL APPLICABLE CODES. THIS IS THE CONTRACTOR'S RESPONSIBILITY.
- ALL AIR DEVICES SHALL BE OF ALUMINUM CONSTRUCTION. TITUS, METALAIR OR AS APPROVED BY ENGINEER.
- HVAC SUBCONTRACTOR SHALL COMFORT BALANCE TENANT AREA TO THE SATISFACTION OF THE LANDLORD AND/OR TENANT AFTER OCCUPANCY. PROVIDE AIR BALANCE REPORT AT COMPLETION OF PROJECT TO ENGINEER/TENANT. CFM VALVES CAN BE WITHIN 100% OF THE
- HVAC SUB-CONTRACTOR SHALL PROVIDE ALL CONTACTORS, RELAYS AND THERMOSTATS. THE ELECTRICAL SUBCONTRACTOR SHALL PROVIDE ALL SWITCHES, DISCONNECTS AND CONTROL WIRING. THERMOSTATS SHALL
- BE APPROVED BY EQUIPMENT MANUFACTURER. ALL DUCT SIZES ARE CLEAR INSIDE DIMENSIONS.
- ALL WORK OF THIS TRADE SHALL BE COORDINATED WITH ALL OTHER TRADES TO AVOID ANY INTERFERENCES THAT MAY DELAY PROGRESS OF CONSTRUCTION.
- HVAC SUBCONTRACTOR SHALL INSTALL ALL NECESSARY OFFSETS, BENDS AND TRANSITIONS REQUIRED TO PROVIDE A COMPLETE SYSTEM AT NO ADDITIONAL COST TO OWNER.
- 10. COORDINATE LOCATION OF CEILING DIFFUSERS, GRILLES AND REGISTERS IN THE FIELD WITH ELECTRICAL, LIGHTS AND ARCHITECTURAL ELEMENTS.
- 11. CONTRACTOR SHALL VISIT SITE PRIOR TO BIDDING TO BECOME FAMILIAR WITH EXISTING CONDITIONS. NOTIFY ARCHITECT / ENGINEER WITH ANY DISCREPANCIES IN WRITING. NO CHANGE ORDERS WILL BE ACCEPTED.

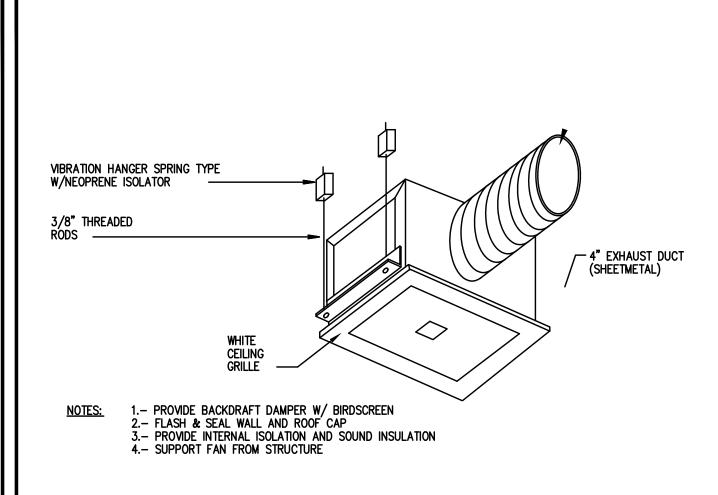



# CABINET EXHAUST FAN DETAIL

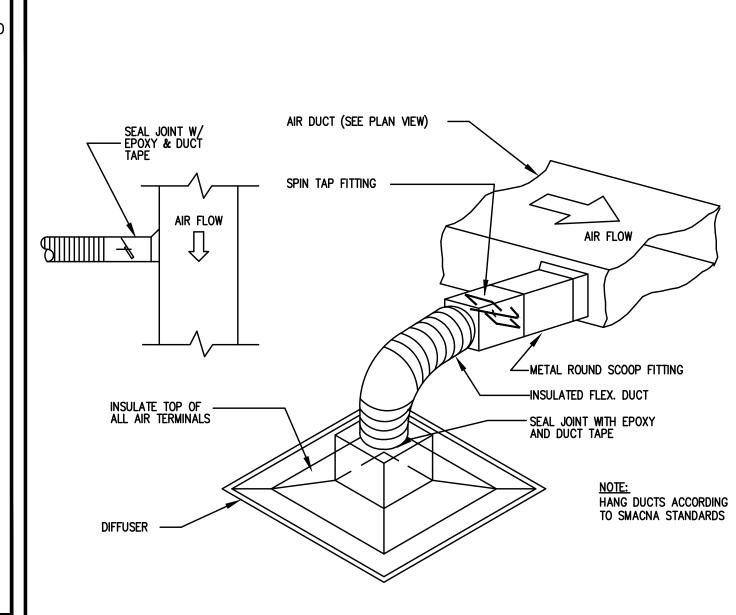

FLEXIBLE DUCT CONNECTION DETAIL

#### AIR DISTRIBUTION SCHEDULE DIFFUSER TYPE CFM DIFFUSER CFM TAG | MANUFACTURER & MODEL NO. | NECK SIZE | CFM | NOTES: 0-100 | ALUMINUM CEILING DIFFUSER TITUS TDC-AA 101-299 LOUVERED FACE 300-450 OPPOSED BLADE DAMPER 10 451–600 12x12 MODULE BORDER TYPE 1 (SURFACE) NC LEVEL < 30 ALUMINUM EGGCRATE RETURN GRILLE 24x24 0-800 TITUS 50F 0-800 | 1/2x1/2x1/2 CORE 0-100 | BORDER\_TYPE\_1 (SURFACE) 101-299 | NC LEVEL < 30 NOTES: ALL FINISHES TO BE WHITE UNLESS OTHERWISE DIRECTED BY THE OWNER OR ARCHITECT

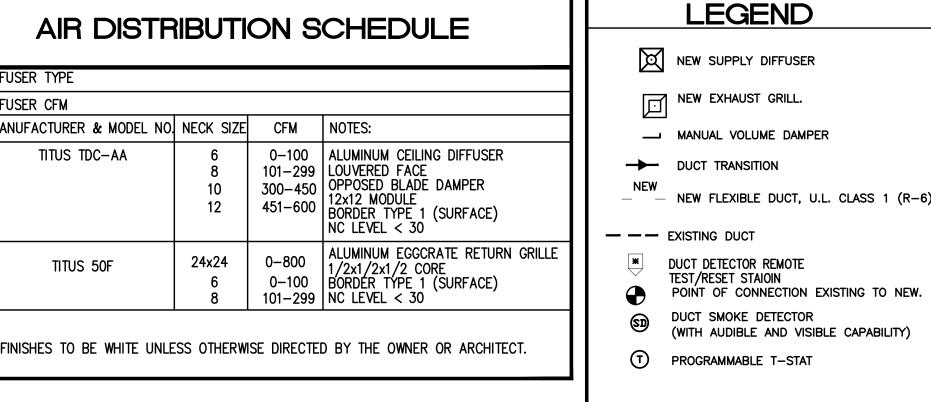

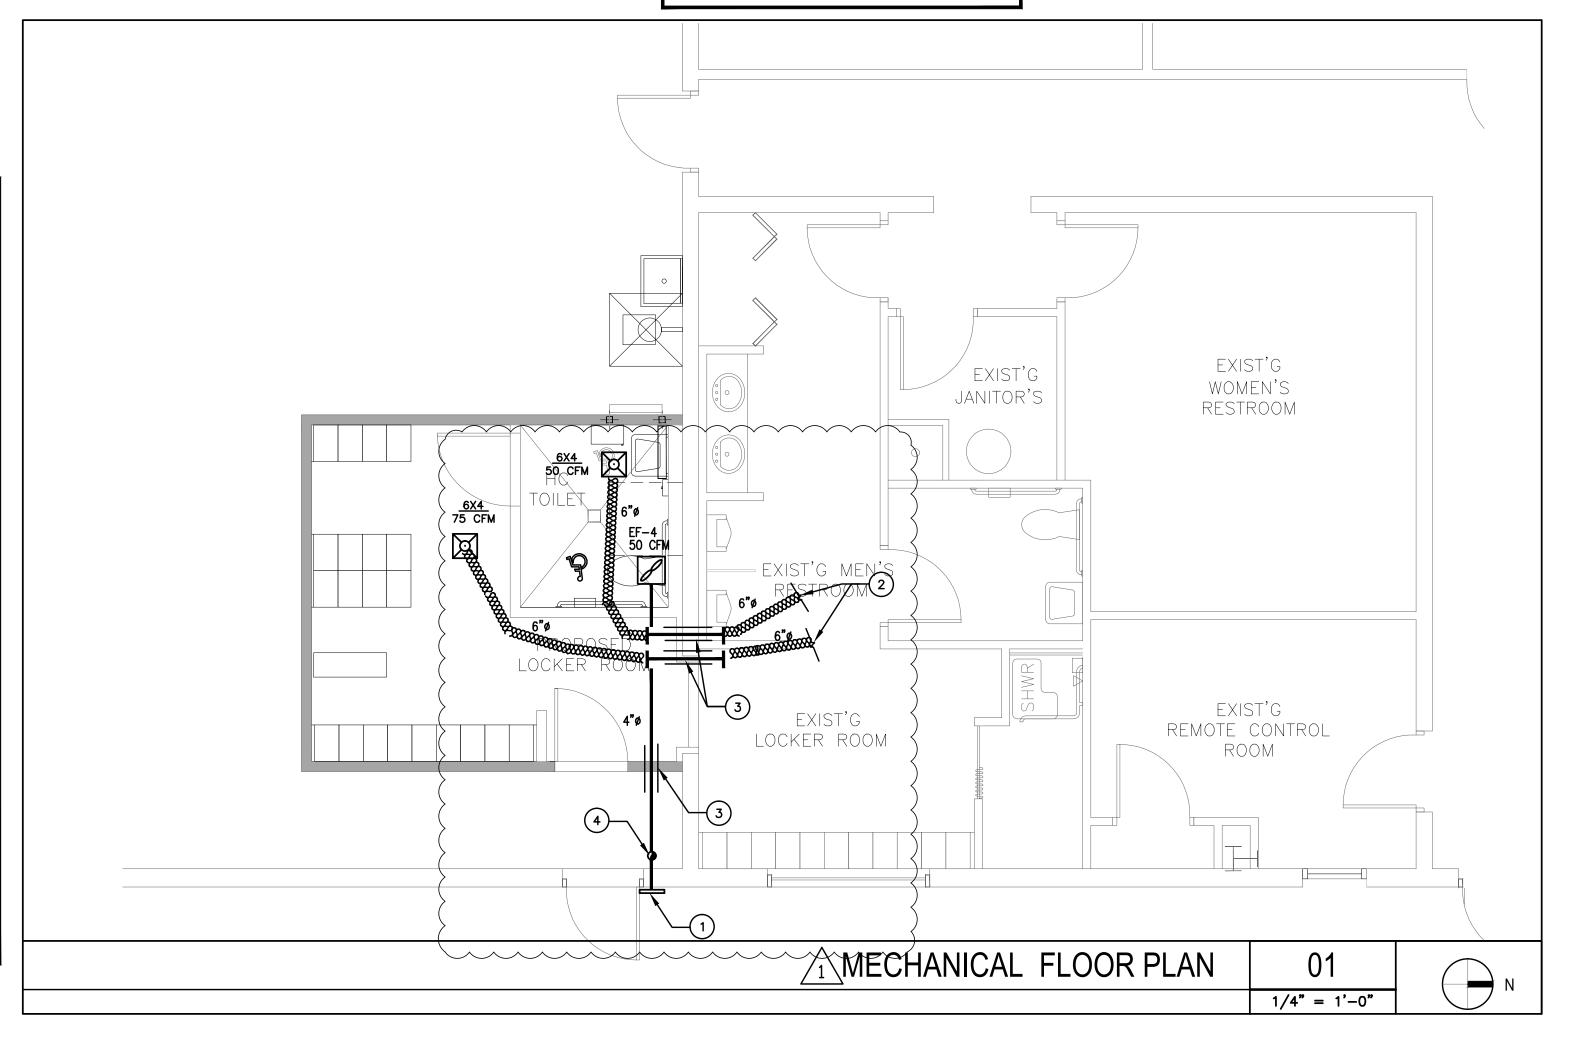

# FAN SCHEDULE

	SELECTION BASED ON		TYPE/	CFM	TSP	RPM	MOTOR DATA			DRIVE	SONES	UNIT	REMARKS
	MAKE	MODEL NO.	SERVICE		IN WG		HP	RPM	VOLTS-PH-HZ		OR NC	WEIGHT	
EF-4	GREENHECK	SP-80	BATHROOM EXHAUST	80	0.20	482	ı	900	120-1-60	DIRECT	2.0	-	1,2,5,8,9

### GENERAL FAN NOTES:

- PROVIDE DISDONNECTS AND ALL ASSOCIATED CONTROLS
- 2. PROVIDE BACKDRAFT FOR ALL EXHAUST FANS.
- FIELD ADJUST OPENINGS WITH STRUCTURE.
- ALL OUTDOOR EQUIPMENT SHALL COMPLY WITH LOCAL ZONING NOISE ORDINANCE OR NOT EXCEED A NOISE LEVEL OF 55dB AS MEASURED RADIALLY 15 FT. FROM THE EQUIPMENT IN ALL DIRECTIONS.
- COORDINATE WITH ELECTRICAL CONTRACTOR BEFORE BIDDING OR ORDERING ANY EQUIPMENT. 6. SEE GENERAL, AIR CONDITIONING, DUCTWORK, AND COORDINATION NOTES FOR OTHER FIELD SUPPLIED ITEMS.
- 7. PROVIDE MOTOR HEATERS SIZED AS REQUIRED FOR FIELD CONDITIONS. 8. PROVIDE BIRDSCREEN ON ALL INLETS AND OUTLETS.
- 9. INTER-LOCK WITH LIGHT SWITCH

10. RUN CONTINUOUSLY

EXHAUST AIR SUMMARY (FBC TABLE 403.3) <u>CFM</u> <u>PROVIDE</u> <u>EXHAUST REQ.</u> <u>EXHAUST</u> CFM EXHAUST/ <u>AREA</u> <u>SYSTEM</u> <u>COUNT</u> <u>FIXTURE</u> <u>SQ\_FT</u> NEW BATHROOM EF-4 70 70 80 EXISTING EF-3 85/LOCKER RM NEW LOCKER 25

### **MECHANICAL DRAWING KEYNOTES**

- (1) 4" SHEET METAL BATHROOM EXHAUST DUCT THROUGH WALL WILL INSECT SCREEN WALL CAP. WALL CAP SHALL BE MINIMUM 3 FEET FROM ANY OPERABLE OPENING. TIE NEW FLEX DUCT TO EXISTING MAIN TRUNK. CONTRACTOR TO FIELD VERIFY EXACT
- LOCATION
- FIRE DAMPER IS NOT REQUIRED PER FBC (MECHANICAL) SECTION 607.5.3 (3) 3.1 DUCT CONTRUCTION SHALL MEET FBC (MECHANICAL) SECTION 603.
- (4) TURN 4" BATHROOM EXHAUST UP

381 SE 10th Street, Pompano Beach, FL 33060 TEL:(954) 461-4314 Fax:(954) 782-2036 Info@bachengineers.com CA#28826

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**SWA-PBC MAINTENANCE FACILITY** LOCKER ROOM



6527 N. Jog Road West Palm Beach, FL 33412

Key Plan:

/1ackslash ADDENDUM 1 09/27/2016

07/14/2016 S+A Project No: 16003 Owner Project No Drawn By 3

Checked By Phase:

PERMIT SET

Sheet Title :

**MECHANICAL PLAN** 

Sheet # :