
HVAC GENERAL NOTES

- GENERAL
- A. ALL WORK SHALL BE DONE IN ACCORDANCE WITH THE FLORIDA
- BUILDING CODE AND WITH ALL APPLICABLE REGULATIONS. B. DRAWINGS: REFER TO ALL DRAWINGS FOR COORDINATION OF THE HVAC WORK. C. ARRANGE AND PAY FOR ALL PERMITS LICENSES, INSPECTIONS AND TESTS.
- OBTAIN THE REQUIRED CERTIFICATES AND PRESENT TO OWNER. D. GUARANTEE: THE COMPLETED INSTALLATION SHALL BE FULLY GUARANTEED AGAINST DEFECTIVE MATERIALS AND/OR IMPROPER WORKMANSHIP FOR A MINIMUM OF ONE YEAR FOR MATERIAL AND LABOR. ALL COMPRESSORS SHALL BE GUARANTEED FOR 5 YEARS MINIMUM.
- 2. SHOP DRAWINGS: CONTRACTORS SHALL SUBMIT FOR APPROVAL, WITHIN 30 DAYS AFTER SIGNING CONTRACT, A MINIMUM OF FIVE COPIES OF FULLY DESCRIPTIVE LITERATURE, INCLUDING BUT NOT LIMITED TO: AIR CONDITIONING UNITS, FANS AND AIR OUTLETS. NO WORK SHALL PROCEED WITHOUT APPROVAL OF THESE SUBMITTALS.
- 3. DESIGN PARAMETERS:
- A. INDOOR DESIGN TEMPERATURE (SUMMER): 78F DB B. INDOOR DESIGN TEMPERATURE (WINTER): 72F DB
- 4. ALL THERMOSTATS SHALL HAVE HEATING MODE MAXIMUM SETTING OF 75 F, AND COOLING MODE MINIMUM SETTING OF 70 F. THE THERMOSTAT SHALL BE ARRANGED TO PREVENT THE SIMULTANEOUS OPERATION OF HEATING AND COOLING.
- 5. ELECTRICAL CONTROLS AND POWER WIRING: UNDER ELECTRICAL CONTRACT.
- 6. EQUIPMENT SPECIFIED BY MANUFACTURER'S NUMBER SHALL INCLUDE ALL ACCESSORIES, CONTROLS, ETC., LISTED IN THE CATALOG AS STANDARD WITH THE EQUIPMENT. OPTIONAL OR ADDITIONAL ACCESSORIES SHALL BE FURNISHED AS
- 7. MATERIALS:
- A. REFRIGERANT PIPING: SHALL BE TYPE L SOFT DRAWN, COPPER TUBING, DEHYDRATED FOR REFRIGERANT USE. SIZED AS SHOWN ON DRAWINGS OR AS PER AIR CONDITIONING EQUIPMENT MANUFACTURER'S RECOMMENDATIONS.
- B. INSULATION: REFRIGERANT SUCTION PIPING AND CONDENSATE PIPES SHALL BE INSULATED WITH 3/4" THICK FOAMED PLASTIC INSULATION, FIRE RETARDANT TYPE. INSULATION SHALL BE INSTALLED IN PIPING BEFORE ASSEMBLY. NO SPLIT INSULATION WILL BE ACCEPTABLE. SEAL JOINTS WITH MANUFACTURER'S APPROVED ADHESIVE AND GREY TAPE.
- A. ALL SUPPLY AIR DUCTWORK SHALL BE 1-1/2" THICK FIBERGLASS DUCTBOARD, FABRICATED AND INSTALLED AS PER LATEST EDITION OF SMACNA "FIBROUS GLASS DUCT MANUAL". R-6.0 MIN.
- B. ALL OUTDOOR AND EXHAUST AIR DUCTWORK SHALL BE GALVANIZED SHEET METAL OR ALUMINUM DUCT NOT LIGHTER THAN 24 GAGE.
- C. ALL DUCT DIMENSIONS ARE CLEAR INSIDE DIMENSIONS.
- D. FLEXIBLE INSULATED DUCTWORK WITH 1-1/2" THICK FIBERGLASS INSULATION WITH FRK VAPOR BARRIER. R-6.0 MIN.
- 8. CONTROLS: AIR CONDITIONING UNITS SHALL BE STARTED AND STOPPED THRU INDIVIDUAL PROGRAMMABLE THERMOSTAT. INDIVIDUAL THERMOSTATS SHALL START/STOP FANS AND ACTIVATE COOLING/HEATING SYSTEMS AS SELECTED.
- 9. TEST AND BALANCE: CONTRACTOR SHALL TEST AND BALANCE ALL VENTILATION AND AIR CONDITIONING SYSTEMS. SUBMIT FOUR COPIES OF TEST AND BALANCE REPORT, TO OWNER FOR APPROVAL.
- 10. ALL WORK SHALL BE COORDINATED WITH OTHER TRADES TO AVOID ANY INTERFERENCES THAT MAY DELAY PROGRESS OF CONSTRUCTION. CONTRACTOR SHALL INSTALL ALL NECESSARY OFFSETS, BENDS, AND TRANSITIONS REQUIRED TO PROVIDE A COMPLETE SYSTEM AT NO ADDITIONAL COST TO OWNER.

AIR DISTRIBUTION SCHEDULE DIFFUSER TYPE CFM DIFFUSER CFM TAG | MANUFACTURER & MODEL NO NECK SIZE | CFM | NOTES: 0-100 ALUMINUM CEILING DIFFUSER MATCH EXISTISTING 8 101–299 LOUVERED FACE 10 300–450 OPPOSED BLADE DAMPER 12x12 MODULE BORDER TYPE 1 (SURFACE) NC LEVEL < 30 0-800 ALUMINUM PERFORATED RETURN PANEL 1/2x1/2x1/2 CORE BORDER TYPE 1 (SURFACE) 24x24 MATCH EXISTING 8 | 101-299 | NC LEVEL < 30 ` 10 300-450 NOTES: 1. ALL FINISHES TO BE WHITE UNLESS OTHERWISE DIRECTED BY THE OWNER OR ARCHITECT.

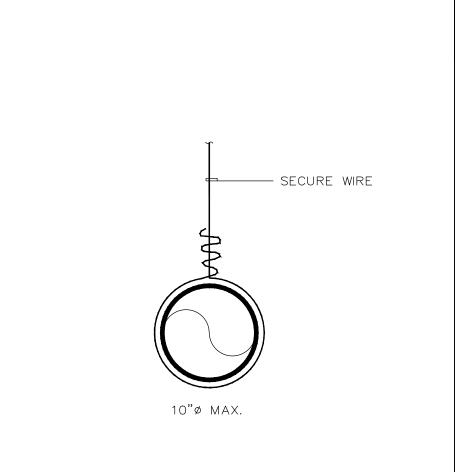

METHODS OF HANGING **DUCTS DETAIL**


CEILING SUPPLY DIFFUSER MANUAL VOLUME DAMPER


PROVIDE PROGRAMABLE T-STAT.

WWW. NEW FLEXIBLE DUCT, U.L. CLASS 1 (R-6)

NEW FIBERGLASS DUCT (R-6)

2-HR RATED FIRE DAMPER

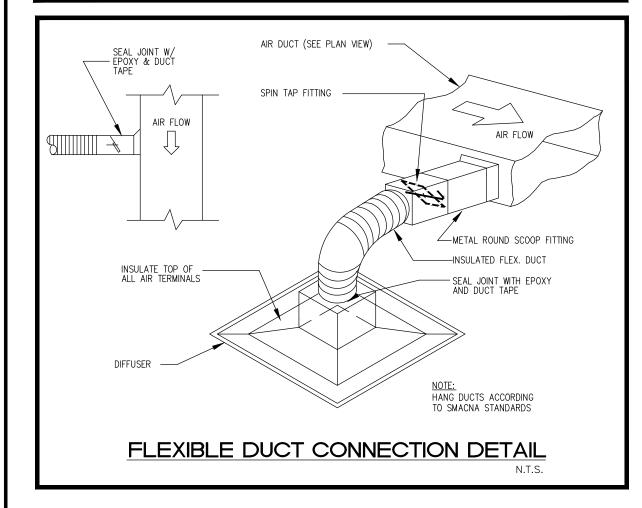

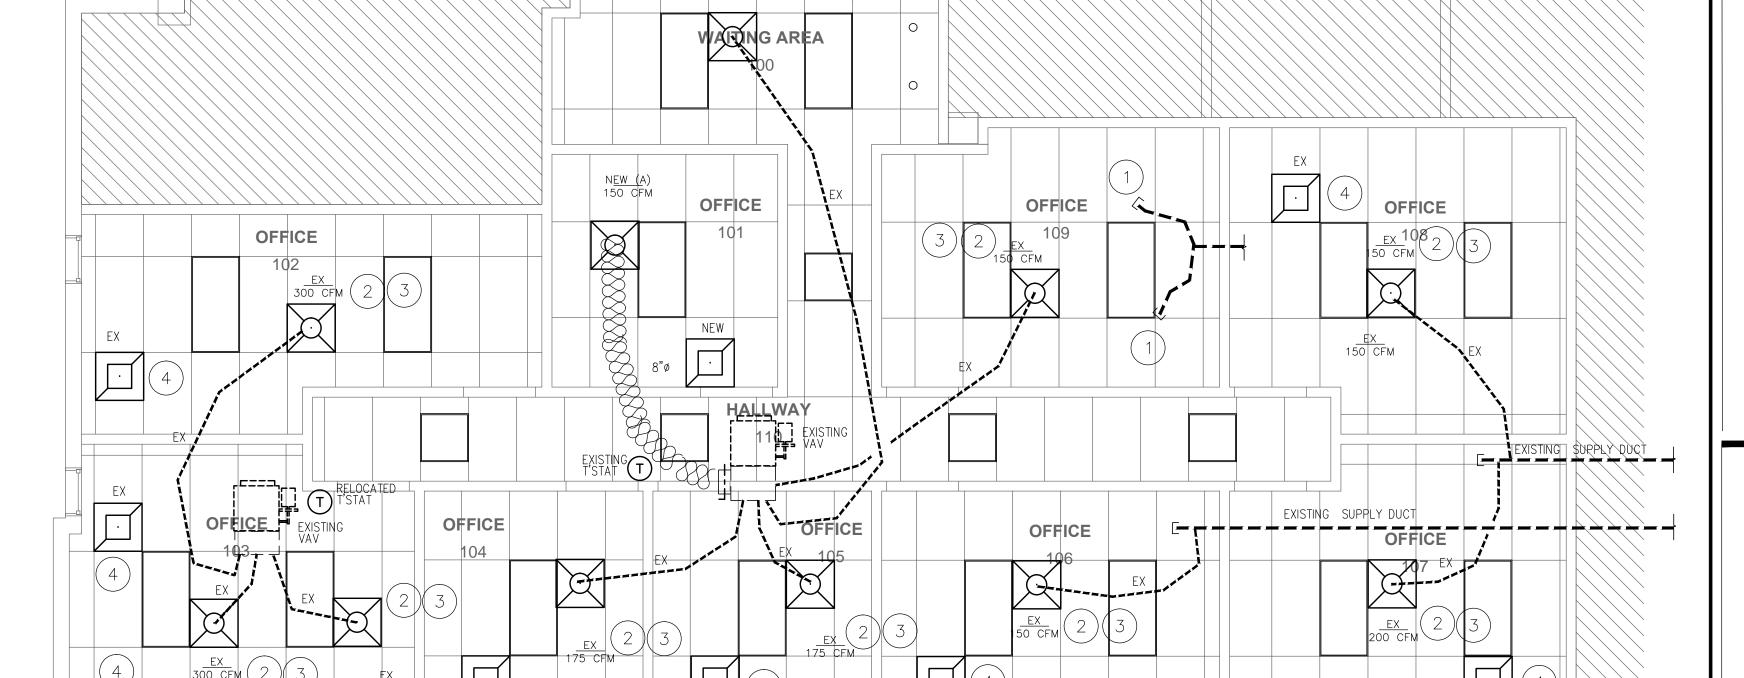

scale: 1/4" = 1'-0"

DRAWING KEYNOTES

RELOCATED EXISTING SUPPLY DIFFUSER TO NEW LOCATION AS

RELOCATED EXISTING RETURN GRILL TO NEW LOCATIONS AS

CAP EXISTING BATHROOM EXHAUST AS REQUIRED

SHOWN. EXTEND FLEX DUCT AS REQUIRED

ADJUST CFM TO VALUE AS SHOWN.

SHOWN.

499 East Palmetto Park Rd. Suite 204 Boca Raton, FL 33432

T 561.479.9884 www.ccsarch.com Florida Registration Number

CONSULTANTS:

AA26001852

ELECTRICAL, MECHANICAL, PLUMBING:

AMERICAN UNITED ENGINEERS 4508 SW 24TH STREET FORT LAUDERDALE, FL 33317 PHONE: (954) 471-8657

SUITE 300 WORLD EXECUTIVE CENTER 3500 N STATE ROAD 7 LAUDERDALE LAKES, FL 33319

INTERIOR IMPROVEMENTS

CONSTRUCTION DOCUMENTS

| PROJECT NUMBER: DATE: CAD FILE NO: | 2016. 05-11 |
|--|----------------|
| ADDENDA/REVISIONS | |

SEAL:

CYNTHIA C. SPRAY, AIA AR-94167

DRAWING TITLE: MECHANICAL PLAN

DRAWING NO:

Dedicated to Excellence Tel: (954) 471-8657 CA # 29803 american-eng@comcast.net

AMERICAN UNITED

Engineers Inc.

ALL APPLICABLE CODES

1624.00

Viet Bach Nguyen, LICENSE No. 69753

STATE OF FLORIDA