
KEYNOTES

- CONTRACTOR TO FURNISH AND INSTALL 1/2" COPPER WATER PIPE, TERMINATE IN 1/2" F.P.T. FOR VACUUM PUMP.
- 2" PVC FOR AIR COMPRESSOR INTAKE UP THROUGH ROOF TO GOOSENECK INTAKE MAINTAIN 10 FEET CLEARENCE FROM EXHAUST VENTS
- VACUUM PUMP DISCHARGE PIPE SHALL ROUTE OVER SANITARY SEWER SYSTEM
- 4 1/2" COPPER COMPRESSED AIR LINE SHALL TERMINATE IN 1/4" F.P.T.
- 5 2" PVC FOR VACUUM VENT THROUGH ROOF TO GOOSENECK VENT
- ROUTE VACUUM AND COMPRESSED AIR UNDER SLAB TO UTILITY JUNCTION BOX.

GENERAL NOTES

- 1. VACUUM LINES SHALL BE AS SCHEDULE 40 PVC WITH 5/8" STUB OUTS AT EQUIPMENT.
- 2. ALL VACUUM LINES SHALL BE INSTALLED UNDER SLAB UNLESS OTHERWISE APPROVED BY TENNANT OR REQUIRED BY PERMITTING.
- 3. AIR COMPRESSOR AND VACUUM PUMP ARE SUPPLIED BY OWNER, INSTALLED BY PLUMING CONTRACTOR AND WIRED BY ELECTRICAL CONTRACTOR.
- 4. COMPRESSED AIR LINES SHALL BE 1/2" COPPER WITH 3/8" COMPRESSION FITTINGS.
- 5. CONTRACTOR SHALL COORDINATE ALL ROUGH IN LOCATIONS WITH EQUIPMENT SUPPLIER AND VERIFY OUTLET SIZES PRIOR TO CONSTRUCTION.

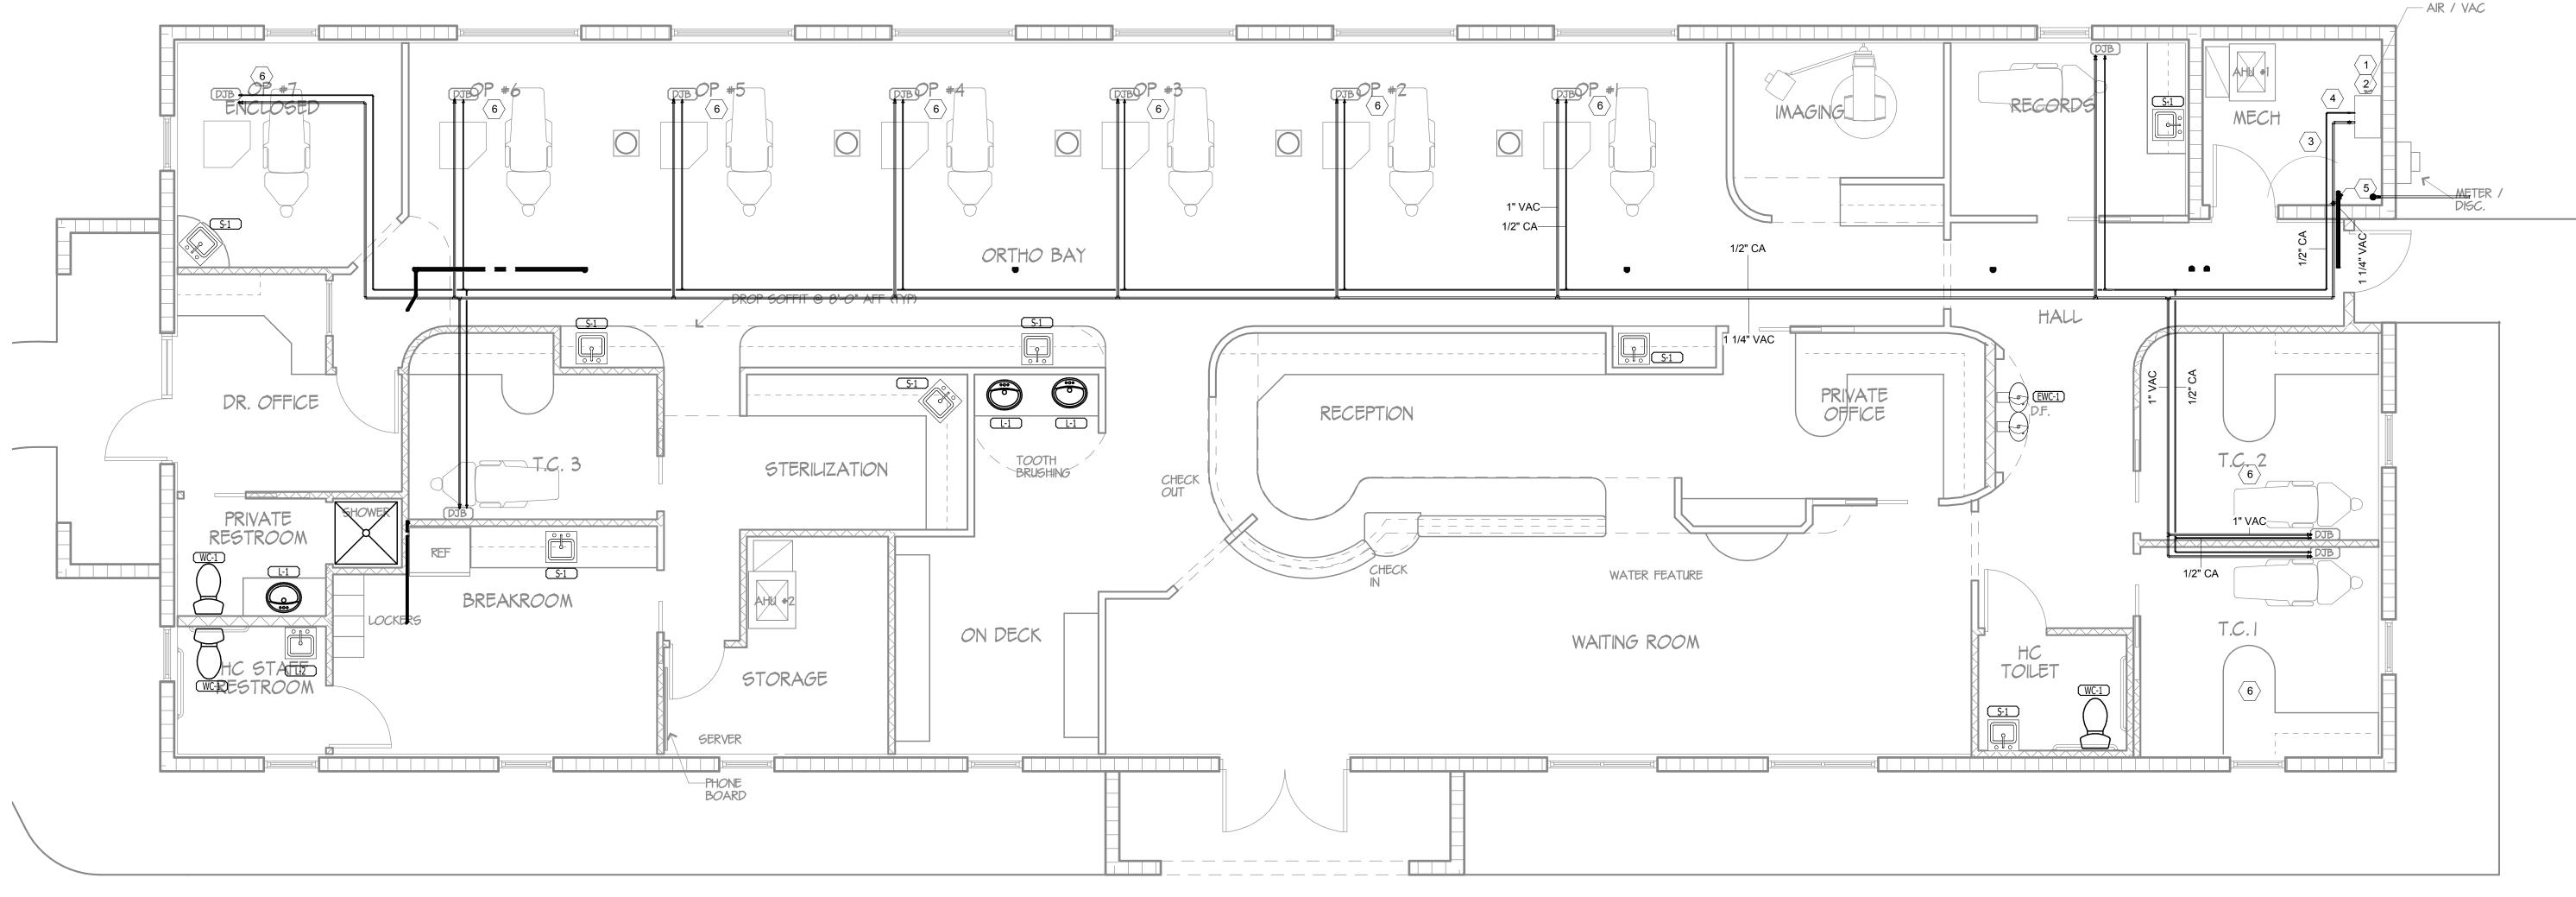

Compressed Air/Vacuum Floor Plan
1/4" = 1'-0"

REVISIONS

REVISION 1 2/4/16

JOB NO. 11-523

DATE 01.28.16

DRAWN BY LTB
CHECKED BY JTW

SHEET