- 1. THIS DRAWING LOCATES FINAL ELECTRICAL POINTS OF CONNECTION FOR EACH FOODSERVICE EQUIPMENT ITEM. IT DOES NOT INDICATE UTILITY ROUGH-IN LOCATIONS AND MUST NOT BE USED FOR THAT PURPOSE. LOCATIONS, SIZES, AND HEIGHTS ABOVE THE FLOOR ARE APPROXIMATELY AS THEY WILL OCCUR ON THE EQUIPMENT ITEMS SHOWN. THE DESIGN OF SYSTEMS TO ACCOMMODATE THESE REQUIREMENTS IS TO BE IN ACCORDANCE WITH ALL APPLICABLE CODES AND MEET WITH THE APPROVAL OF ALL GOVERNING AUTHORITIES.
- UTILITIES SHOWN ARE FOR FOODSERVICE EQUIPMENT ITEMS ONLY. THIS DRAWING MUST BE USED IN CONJUNCTION WITH THE ELECTRICAL DRAWINGS FOR OTHER REQUIRED
- CONCEAL ALL UTILITIES IN WALLS AND STUB-OUT OF WALLS AS REQUIRED FOR CONNECTIONS. DO NOT RUN EXPOSED ON THE FACE OF THE WALL. DO NOT STUB-OUT OF THE FLOOR UNLESS IT IS BELOW FREESTANDING EQUIPMENT.
- EXPOSED CONDUIT ABOVE WORK SURFACES TO BE STAINLESS STEEL. EXPOSED CONDUIT BELOW WORK SURFACES TO BE CHROME PAINTED.
- POWER TO ALL ELECTRICALLY OPERATED EQUIPMENT UNDER HOODS IS TO COME FROM THE PANEL WHERE THE MAIN BREAKER IS INTERWIRED WITH THE FIRE EXTINGUISHING SYSTEM SO THAT POWER SHUT-OFF IS ACHIEVED UPON EITHER MANUAL OR AUTOMATIC
- OPERATION OF THE FIRE EXTINGUISHING SYSTEM. PROVIDE A FLUSH, EMPTY JUNCTION BOX AT EACH REMOTE FIRE CABLE PULL. PROVIDE CONDUIT CONCEALED IN WALL FROM JUNCTION BOX TO A POINT 6"(155mm) ABOVE FINISHED CEILING.
- PROVIDE CONDUIT AND WIRING BETWEEN THE FUEL LINE SOLENOID SHUT-OFF VALVES, SHUNT TRIP BREAKERS, CONTACTORS, REMOTE NOTIFICATION AND FIRE EXTINGUISHING SYSTEMS.
- NOT USED.
- NOT USED.
- NOT USED. A MECHANICAL GAS SHUT OFF VALVE OR ELECTRICAL SOLENOID SHUT OFF VALVE WITH MOMENTARY POWER INTERRUPTION DEVICE SHALL BE PROVIDED LOOSE BY KEC FOR FIELD INSTALLATION IN SUPPLY LINE FOR GAS FUELED EQUIPMENT ITEMS.
- PROVIDE DUPLEX CONVENIENCE OUTLET (120/10, 20A) AT HEIGHT INDICATED. COORDINATE THE INTERWIRE OF ALL SPECIFIED TEMPERATURE ALARM SYSTEMS TO BUILDING
- 14. VENTILATORS SHALL INCLUDE THERMOSTAT(S) INSTALLED IN THE CANOPY TO AUTOMATICALLY START THE EXHAUST FAN(S) WHEN COOKING OCCURS TO MEET IMC 2006 SECTION 507.2.1.1.
- 15. ELECTRICAL PANELS TO BE LOCATED WITHIN LINE OF SIGHT OF EQUIPMENT SERVED BY PANELS AND NOT FURTHER AWAY FROM EQUIPMENT THAN LOCAL CODE REQUIREMENTS ALLOW.

ELECTRICAL ABBREVIATION	S AND SYMBOI	LS
OWITOLI	S	

SWITCH	SW	(S)
ELECTRICAL CONNECTION	EC	0
JUNCTION BOX	JB	\bigcirc
SINGLE RECEPTACLE	SR	ф
DUPLEX RECEPTACLE	DR	Ф
DATA COMMUNICATIONS	DC	D
EMPTY JUNCTION BOX		4
AMP	Α	
KILOWATT	KW	
HORSEPOWER	HP	
VOLT	٧	
PHASE	Ø	
ABOVE FINISHED FLOOR	AFF	
DOWN FROM ABOVE	DFA	

REFER TO SHEET QF105 FOR ELECTRICAL UTILITY LOAD SCHEDULE


FIRE EXTINGUISHING SYSTEM NOTES

FA	WIRING IN CONDUIT BY ELECTRICAL TRADE BETWEEN RESET RELAY, AUTOMAN RELEASE AND ELECTRICAL GAS SOLENOID SHUT—OFF VALVE
FB	WIRING IN CONDUIT BY ELECTRICAL TRADE TO SHUNT—TRIP BREAKER LOCATED IN POWER PANEL SUPPLYING EQUIPMENT BENEATH VENTILATOR AND/OR BETWEEN RESET RELAY AND CONTACTORS SERVING EQUIPMENT BENEATH VENTILATOR
FC	WIRING IN CONDUIT BY ELECTRICAL TRADE BETWEEN MICROSWITCH AND BUILDING FIRE ALARM SYSTEM AS REQUIRED
	FLUSH-MOUNT OCTAGONAL J-BOX (8B TYPE) MOUNTED AT 48"(1200mm) TO 54"(1350mm) AFF

MOUNTED AT 48"(1200mm) TO 54"(1350mm) AFF WITH 1/2" (15mm) EMT TO 6"(150mm) ABOVE CEILING BY ELECTRICAL TRADE FOR REMOTE CABLE PULL (HEIGHT VARIES PER LOCAL CODES)

WIRING IN CONDUIT BY ELECTRICAL TRADE BETWEEN MICROSWITCH AND FIRE TERMINAL BLOCK IN UDS


FF ELECTRIC GAS SOLENOID SHUT OFF VALVE IS REQUIRED, WIRING IN CONDUIT BY ELECTRICAL TRADE BETWEEN MOMENTARY POWER INTERRUPTION DEVICE, RESET RELAY AND GAS SOLENOID VALVE

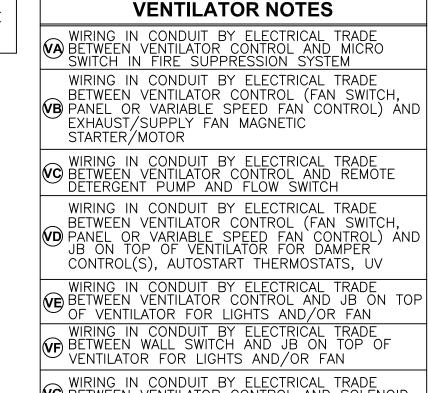

NOTE: THIS DRAWING IS FOR INFORMATION ONLY.

GENERAL CONTRACTOR SHALL COORDINATE WITH THE KITCHEN EQUIPMENT SUB-CONTRACTOR AND RELATED MECHANICAL, ELECTRICAL AND PLUMBING SUB-CONTRACTORS TO ESTABLISH FINAL SPOT CONNECTIONS LOCATIONS AND CONFIGURATIONS AS REQUIRED. THIS DRAWING SHALL NOT BE USED TO LOCATE ANY UTILITY CONNECTIONS IN THE FIELD OR TO LOCATE ANY ROUGH-IN, PENETRATION, OR OTHER REQUIREMENTS.

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BETWEEN VENTILATOR CONTROL (FAN SWITCH,
PANEL OR VARIABLE SPEED FAN CONTROL) AND
JB ON TOP OF VENTILATOR FOR DAMPER WIRING IN CONDUIT BY ELECTRICAL TRADE
BETWEEN VENTILATOR CONTROL AND JB ON TOP
OF VENTILATOR FOR LIGHTS AND/OR FAN WIRING IN CONDUIT BY ELECTRICAL TRADE BETWEEN VENTILATOR CONTROL AND SOLENOID AT PLUMBING ASSEMBLY ABOVE VENTILATOR

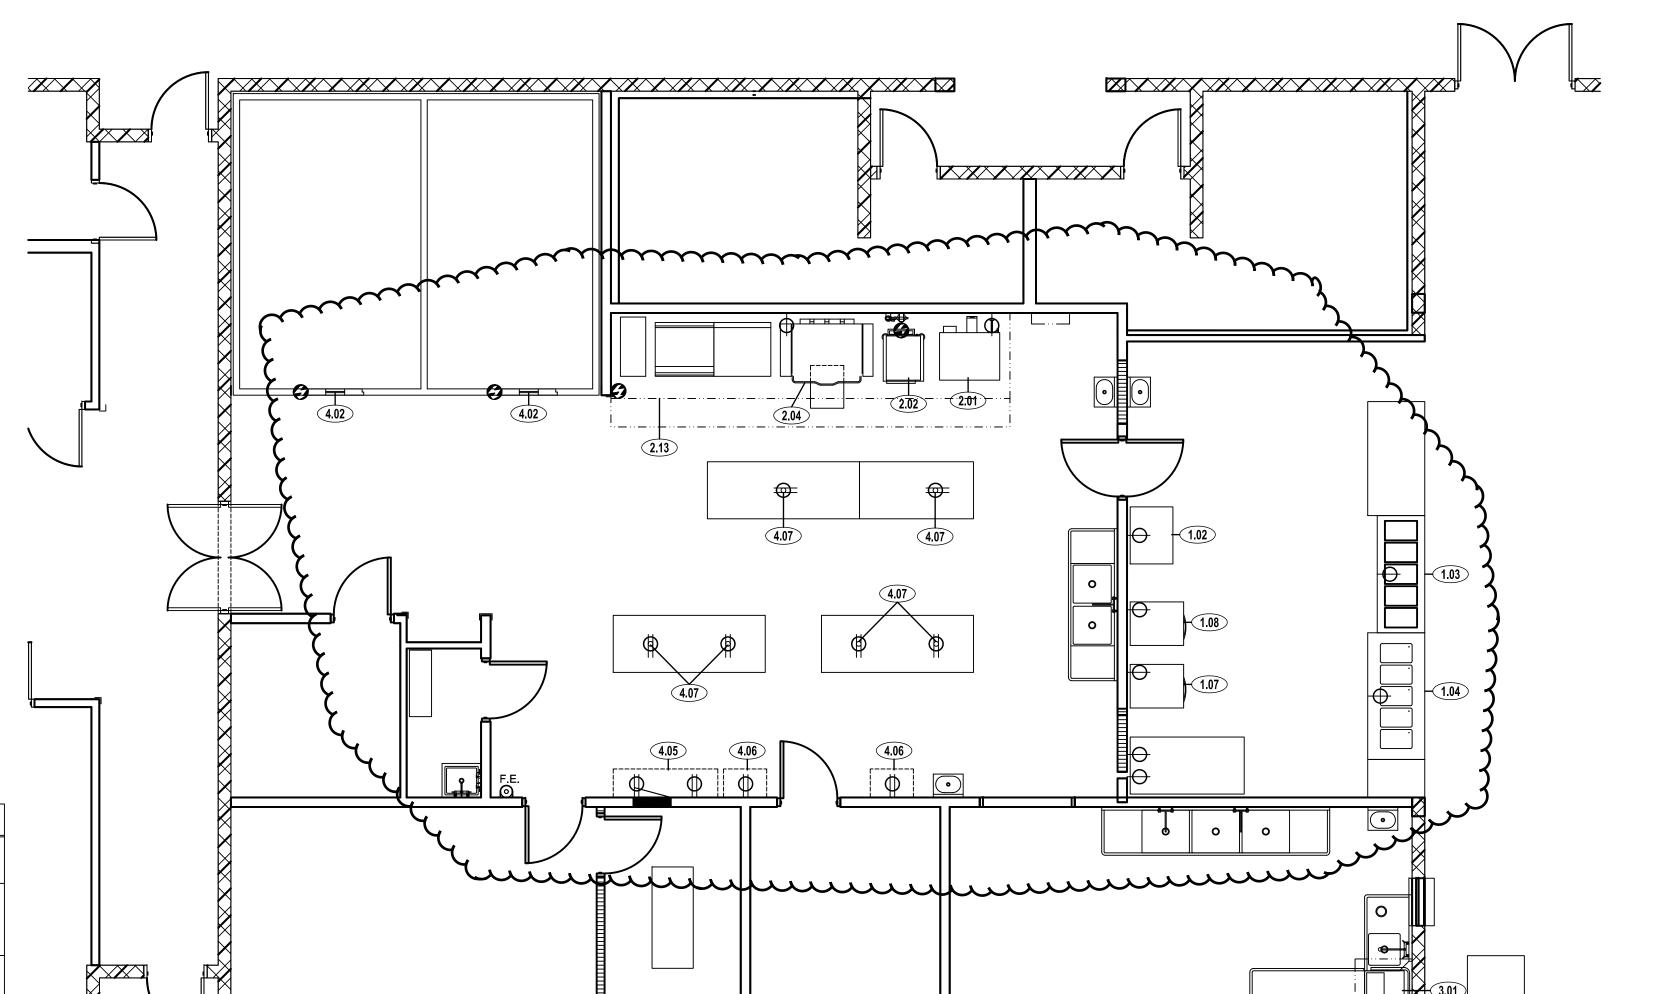WIRING IN CONDUIT BY ELECTRICAL TRADE
BETWEEN VENTILATOR CONTROL AND VARIABLE
SPEED FAN CONTROL

WIRING IN CONDUIT BY ELECTRICAL TRADE

(VI) BETWEEN VENTILATOR CONTROL AND BUILDING $^\prime$ management system (and demand ventilation



CHICAGO CLEVELAND FT. LAUDERDALE LOS ANGELES NEW YORK SAN FRANCISCO

REV. DATE REVISION DESCRIPTION

1 10/10/16 PERMIT RESUBMITTAL

PROJECT NAME

NORTH HOMELESS ASSISTANCE CENTER FT. LAUDERDALE, FL

SHEET TITLE

FOODSERVICE EQUIPMENT ELECTRICAL SPOT CONNECTION PLAN

PROJECT MGR/DRN: SW/CAD 1/4" = 1'-0SCALE: PROJECT NO: 16-0046-0 ISSUE DATE: SHEET NUMBER

